



UNIVERSITY OF KENTUCKY Purchasing Division

INVITATION FOR BIDS

CCK-2655-23

ADDENDUM# 6

10/11/2022

ATTENTION: This is not an order. Read all instructions, terms and conditions carefully.

IMPORTANT: BID AND ADDENDUM MUST BE RECEIVED BY: 10/18/2022 @ 3:00 P.M. LEXINGTON, KY TIME

Bidder must acknowledge receipt of this, and any addendum as stated in the Invitation for Bids.

1. Please review and incorporate the attached information from Turner Construction and GBBN Architects, into your bid.
2. If you have any questions, please contact Ken Scott at the number below or at kenneth.scott@uky.edu.

OFFICIAL APPROVAL
UNIVERSITY OF KENTUCKY

SIGNATURE

Ken Scott

10/11/2022

Ken Scott / 859-257-9102

Typed or Printed Name

UK Level B Support Services BP-2
ADDENDUM No. 6
CCK-2655-23
10/11/2022

- Item No. 01** Re: Form of Proposal TC-209, General Trades, Attachment B, revise item 16.b. to this contractor's scope of work.
- b) This contractor to provide demo per notes D1 (Partial), D2 (Complete), D4 (Complete), D9 (Complete), D11 (Complete), D13 (Complete), D14 (Complete), D15 (Complete), D16 (Complete), D17 (Complete), and D18 (Complete), D22 (Complete), D23 (Complete), D25 (Complete), D28 (Partial), D30 (Complete), D31 (Partial), D32 (Partial). (ADD #6)
- Item No. 02** Re: Form of Proposal TC-209, General Trades, Attachment B, add item 16.b.ii. to this contractor's scope of work.
- ii) For Note D15, Contractor shall include excavation and prep for depressed slab shown on Detail B/S100B. (ADD #6)
- Item No. 03** Re: Form of Proposal TC-209, General Trades, Attachment B, add item 17.b. to this contractor's scope of work.
- b) Include depressed slab as shown on A/S100B. Reference S301 S100A and S100B for typical slab replacement details. (ADD #6)
- Item No. 04** Re: Form of Proposal TC-209, General Trades, Attachment B, add item 17.c. to this contractor's scope of work.
- c) Include Note A13 on A10B-A.3 pertaining to concrete in-fill of existing recessed slab. (ADD #6)
- Item No. 05** Re: Form of Proposal TC-209, General Trades, Attachment B, remove item 19.b. from this contractor's scope of work.
- Item No. 06** Re: Form of Proposal TC-209, General Trades, Attachment B, revise item 19.c. for this contractor's scope of work.
- c) This contractor to specifically provide and install toilet partition supports per S204 detail D/S100B (ADD #6)
- Item No. 07** Re: Form of Proposal TC-214, Plumbing and Mechanical, Attachment B, add item 17.e.i. to this contractor's scope of work.
- i) TC-215 contractor to provide (1) 480 3 Phase 60amp circuit. The intent for this circuit is for electric excavation for new underground plumbing as no diesel or gasoline powered equipment shall be permitted indoors. The connection point for this equipment shall be within 50' of excavation as shown on the demo and plumbing drawings. (ADD #6)
- Item No. 08** Re: Form of Proposal TC-214, Plumbing and Mechanical, Attachment B, add item 17.g. to this contractor's scope of work.
- g) This contractor to include demolition notes D25 (Partial), D27 (Partial), D28 (Partial), D31 (Partial), D32 (Partial). (ADD #6)
- Item No. 09** Re: Form of Proposal TC-215, Electrical and Integrated Technology, Attachment B, add item 20.j. to this contractor's scope of work.
- j) This contractor to include demolition notes D25 (Partial), D27 (Partial), D28 (Partial), D31 (Partial), D32 (Partial). (ADD #6)
- Item No. 10** GBBN Architects Addendum No. 06 – include all work scope items, clarifications, etc. as detailed consistent with your trade contract work scope document.



BP-2_ADDENDUM NO. 6

BY: GBBN Architects, Inc.
609 W Main Street
Louisville, KY 40202
502.583.0700

Subject: Renovate/Upgrade UK Healthcare Facilities
Pavilion A Level B Support Services Renovation
UK # 2239.77

FOR: University of Kentucky
222 Peterson Service Building
Lexington, KY 40506

TO: All Bidders of Record

Acknowledge receipt of this Addendum by inserting its number and date in the space provided on the Bid Form. Failure to do so may subject bidders to disqualification. This Addendum forms a part of the Bidding Documents and revises the Bidding Documents as follows:

PART 1, PROJECT MANUAL

1.1 102213 Wire Mesh Partitions

A. Specification

1.2 08 7100.2 Door Hardware Sets BP2

A. Modifications in RED



PART 2, DRAWINGS

- 2.1 Sheet EQ20BA – 01.31.11 Record Drawing**
- 2.2 Sheet D10B-A.1 LEVEL B DEMOLITION PLAN – AREA A PHASE 1**
 - A. See clouded areas
- 2.3 Sheet D10B-A.2 LEVEL B DEMOLITION PLAN – AREA A PHASE 2**
 - A. See clouded areas
- 2.4 Sheet D10B-A.3 LEVEL B DEMOLITION PLAN – AREA A PHASE 2**
 - A. See clouded areas
- 2.5 Sheet D10B-A.4 LEVEL B DEMOLITION PLAN – AREA A PHASE 2**
 - A. See clouded areas
- 2.6 Sheet D10B-A.5 - LEVEL B DEMOLITION PLAN – AREA A PHASE 5**
 - A. See clouded areas
- 2.7 Sheet D10B-A.6 LEVEL B DEMOLITION PLAN – AREA A PHASE 2**
 - A. See clouded areas
- 2.8 Sheet A10B-A.1 LEVEL B DEMOLITION PLAN – AREA A PHASE 2**
 - A. See clouded areas
- 2.9 Sheet A10B-A.2 LEVEL B DIMENSION PLAN – AREA A PHASE 2**
 - A. See clouded areas and reference numbers in door schedule
- 2.10 Sheet A10B-A.3 LEVEL B DIMENSION PLAN – AREA A PHASE 2**
 - A. See clouded areas and reference numbers in door schedule
- 2.11 Sheet A10B-A.4 LEVEL B DIMENSION PLAN – AREA A PHASE 2**
 - A. See clouded areas and reference numbers in door schedule
- 2.12 Sheet A803 – FM ADMIN – ENLARGED PLANS AND ELEVATIONS**
 - A. See clouded areas



2.13 Sheet S100B – STRUCTURE PLAN AND SECTION

- A. See clouded areas
- B. For slab patching as part of Bid Pack 2, refer to the typical details on sheets S100A and S100B of the Bid Pack 2 bid drawing set.
- C. For restroom partition wall overhead Unistrut, refer to detail D/S100B on the attached S100B sheet

PART 3, ATTACHMENTS

3.1 CMTA Addendum 6 Summary

3.2 Bidder questions

3.3 Specifications

- A. 087100.2 Door Hardware Sets BP2
- B. 102213 Wire Mesh Partitions

3.4 Drawings

- A. EQ20BA – Basement Level Equipment Plan Area – A – Record Drawing
- B. D10B-A.1 Level B Demolition Plan – Area A Phase 1
- C. D10B-A.2 Level B Demolition Plan – Area A Phase 2
- D. D10B-A.3 Level B Demolition Plan – Area A Phase 3
- E. D10B-A.4 Level B Demolition Plan – Area A Phase 4
- F. D10B-A.5 Level B Demolition Plan – Area A Phase 5
- G. D10B-A.6 Level B Demolition Plan – Area A Phase 6
- H. A10B-A.1 Level B Dimension Plan – Area A Phase 1
- I. A10B-A.2 Level B Dimension Plan – Area A Phase 2
- J. A10B-A.3 Level B Dimension Plan – Area A Phase 3
- K. A10B-A.4 Level B Dimension Plan – Area A Phase 4
- L. A803 – FM Admin – Enlarged Plans and Elevations
- M. S100B – Structure Plan and Section
- N. E52B-A – Level 0B – Power – New Work – Area A – Phase 2
- O. E55B-A – Level 0B – Power – New Work – Area A – Phase 5
- P. E56B-A – Level 0B – Power – New Work – Area A – Phase 6
- Q. E66B-A – Level 0B – Systems – New Work – Area A – Phase 6
- R. E101B – Panel Schedules – A
- S. E102B – Panel Schedules – A
- T. P001-A – Plumbing Legend
- U. P31B-A - Level 0B – Plumbing – New Work – Area A – Phase 1
- V. P31BU-A – Underslab – Plumbing New Work Plan – Area A – Phase 1
- W. P32BU-A - Underslab – Plumbing New Work Plan – Area A – Phase 2
- X. P33B-A - Level 0B – Plumbing – New Work – Area A – Phase 3



- Y. P35BU-A - Underslab – Plumbing New Work Plan – Area A – Phase 5
- Z. P36BU-A - Underslab – Plumbing New Work Plan – Area A – Phase 6
- AA. P43 – Enlarged Plumbing Plan – Area A
- BB. P44 – Enlarged Plumbing Plan – Area A
- CC. P45 – Enlarged Plumbing Plan – Area A
- DD. P53-A – Plumbing Details

3.5 Sketches:

1. N/A

END OF ADDENDUM NO. 6

- A. Added data drops in HLD clean A-B421

Item #16 Refer to the Electrical Drawings, Sheet E101B and E102B – PANEL SCHEDULES

- A. Edited circuits for changes noted on above sheets.

END OF ADDENDA ITEMS



UNIVERSITY OF KENTUCKY


Purchasing Division

Written Questions and Answers

CCK-2655-23

PAV A. Basement Renovation

No.	Question	Answer
1.	In the specs Division 8, it asks for submittals for a film to match existing spandrel glass, however I cannot locate any area on the plans that mention the need for film. Please advise.	In section 08 8000: 1.4: F – “Samples of Architectural window film matching existing spandrel” is not in scope for this project.
2.	Mechanical Specifications, Section 201300 – Subsection E: Domestic Cold, Hot and Recirculating Hot Water Piping (Above Slab) Subsection G: Hydronic Piping (Heating Hot Water, Chilled water systems, PET Chilled Water System) Are Victaulic grooved mechanical products an approved pipe joining method for hot and chilled water sizes 2 ½” and larger?	Yes. This shall be reflected in Addendum 03.
3.	Proposed Addendum Wording - - Victaulic 607 or engineer approved equivalent mechanical grooved pipe couplings and fittings may be used in lieu of solder. For potable water, product shall utilize grade “P” EPDM gasket rated from +0°F to +180°F for improved resistance to chlorine, chloramine and other typical potable water disinfectants. Victaulic 608N may be utilized with copper groove system.” - Schedule 40 Victaulic 107V mechanical grooved pipe couplings and fittings with 125# rating minimum may be used. Install gaskets as recommended by the manufacturer. Victaulic Vic-300 Butterfly Valve, 732 Wye Strainer and 716 Check Valve may be used with grooved piping system. Piping system shall be rated for minimum of 250°F water temperature. Mechanical grooved piping may not be used if system water temperature exceeds 250°F.”	This shall be reflected in Addendum 03.

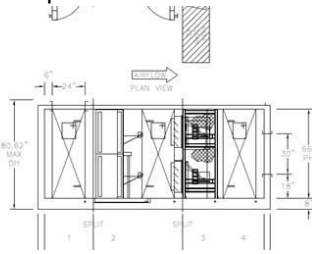4.	<p>The custom AHU also has (2) supply air openings with no return and no OA. The detail drawing also shows that one of the openings is on the end, not top yet AHU section notes as well as isometric view appear to indicate top. Can these points be clarified in the addendum as well?</p> <p>AHU SECTIONS 1. TOP SA INTAKE OPENING 2. CHILLED WATER COOLING COIL(S) 3. SUPPLY FAN MATRIX - MINITOWER 4. 54"x24" TOP SA OPENING</p> 	<p>The AHU specified will take supply air from an existing supply duct distribution system and subcool to a lower leaving temperature. The two “supply air” descriptions are correct. This unit will have top duct connections on either end.</p>
5.	<p>"Volume 4 (000001.4)" is not provided in the bid documents. Please provide clarification for "Owner Furnished" items.</p>	<p>This was issued in Addendum 3 dated 09/13/22</p>
6.	<p>Demo note D18 references "Temporary walls, work by General Trades". Please clarify this scope of work. Is this work the responsibility of TC-209 or TC-210? What type of temporary walls (gyp, plastic sheeting, edgeguard)?</p>	<p>This work is to be completed by TC-209 and EdgeGuard barriers will be used. TC-209 shall assume responsibility of ensuring support and appropriate anchoring of EdgeGuard system where applicable.</p>
7.	<p>Walls to be demolished (shown dashed) are not defined as gyp assemblies/cmu, full height/partial height, or load bearing. For bidding purposes, can wall types schedule for demo be shown or quantified as both TC-209 and TC-210 are responsible for cmu and gyp assembly demolition? Are lead lined walls associated with "radioactive storage room" gyp, cmu, or both? Are cmu walls slushed/grouted? Will the owner remove hazardous materials prior to demo?</p>	<p>"D" sheets in Addendum 6 note concrete masonry unit walls. As a general rule, TC-209 shall be responsible for all CMU demo.</p>
8.	<p>Demo note D11 is included in TC-209 and TC-211 scope of work. Which TC is responsible for flooring and adhesive removal? What is the extent of adhesive removal (scraping, grinding, chemical removal, shotblasting)?</p>	<p>TC-209 is responsible for demo note D11 as this will be needed to facilitate additional demo by other TCs. TC-209 shall assume removal to the extent of making the area safe for foot and lift traffic. TC-211 shall</p>

		assume any additional adhesive removal that's required for new installation is by TC-211.
9.	Demo note D9 "remove existing casework" does not identify quantity or type of casework. For bidding purposes, can casework be quantified? Is casework to be demo'd, salvaged, turned over, relocated, or stored?	It shall be assumed that all casework will be demo'd by TC-209 and transported to the dumpsters as shown in sketch SK-103.
10.	D10B-A.1 shows an existing overhead counter door (Room A0B400) which is shown removed in D10B-A.3. Is this door to be removed & opening filled? Which TC is responsible for demo & infill?	<p>The existing overhead counter door, accessories, and countertop, are to be removed by TC-209. The intent is to match the existing adjacent conditions, which is a gyp board assembly. The infill of this opening is by TC-210.</p> <p>D10B-A.1 room A0B400 does not denote an overhead door to be demolished. D10B-A.2 does show the overhead door at the bottom left dashed and A10B-A.2 shows the infill to be a 1 hour smoke barrier per the Partition and Wall Graphic Key. Infill with wall type 3 SB.</p> <p>See drawings in Addendum 6</p>

11.	Demo note D4 "Remove high density shelving and salvage for reuse": Is the intent that all shelving and railing be removed? Is shelving and railing to be relocated & stored on-site, off-site, or turned over to the owner?	Note is updated in Addendum 6
12.	Demo note D13 "Remove lockers, salvage, and coordinate storage with owner": Is storage of lockers at Pav A, or will lockers need to be relocated off-site?	Note is updated in Addendum 6
13.	Demo notes D14/D17: What are the types of equipment to be removed (makes, models)? Will TC-210 demo gyp around equipment before removal? Will TC-214/TC-215 disconnect equipment/make safe prior to removal? Is storage of equipment at Pav A or off-site?	Note is updated in Addendum 6.
14.	Page A10B-A.3 note A6 "Temporary Lockers": Which trade package is responsible for temporary lockers? What configuration and materials are required?	TC-209 is responsible for the temporary lockers. Two-Tier metal lockers per 10 5113 and/or reused salvaged lockers.
15.	Please provide specifications for "10-2213 Wire Mesh Partitions"	10-2213 Wire Mesh Partitions will be provided in Addendum 6.
16.	Structural plan pages S-201 & S-301 are referenced in scopes and plan notes but not included in bid documents. Please provide.	See Addendum 6 drawings and summary
17.	TC-214, scope #55 "Provide and install any curbs and/or housekeeping pads" conflicts with TC-209, scope #17.a "Provide and install 6" containment curb". Which TC is responsible for curb at new detergent room. Please provide details on curb installation beyond layout on 4/A803.	TC-209 is responsible for the 6" containment curb. TC-214 contractor shall assume all other curbs, as referenced in the TC-214 scope of work, are by TC-214. Detail 7/A803 has been created and released in Addendum 6.
18.	Does wall protection "WC-2" Inpro Stainless Steel Panels require any special backing or blocking substrate. Manufacturer installation is for adhesive installation. Is it assumed that gyp board will be the installation substrate?	Install per manufacturer's recommendations and Installation Instructions and reference dimension plans for installation substrate.

DOOR HARDWARE SETS – BP#2**Hardware Set 05**

DOOR# A0B400C, A0B400E, A0B401, AB505B

3	HINGE	TA2714 4.5 X 4.5	26D	MK
1	CLASSROOM LOCK	JNR8808FL	626	YA
1	HS MORTISE CYL	1E74 CORMAX W/RING	26D	BE
1	KICKPLATE	6 x 34 x .050" x 3BE	32D	RO
1	WALL STOPS	400	26D	RO

HARDWARE SET 05.1

DOOR# A0B400.2, A0B414, A0B332A, A0B412, A0B420, A0B514A

3	HINGE	T4A3786 4.5 X 4.5	26D	MK
1	CLASSROOM LOCK	JNR8808FL	626	YA
1	HS MORTISE CYL	1E74 CORMAX W/RING	26D	BE
1	KICKPLATE	6 x 34 x .050" x 3BE	32D	RO
1	WALL STOPS	400	26D	RO
1	CLOSER	7500	689	NO
1	SET SEALS	5050B		
1	AUTO DOOR BOTTOM	422N		NG

HARDWARE SET 05.2

DOOR# A0B410

ALL HARDWARE BY DOOR MANUFACTURER

HARDWARE SET 05.3

DOOR# A0B415

6	HINGE	TA2714 4.5 X 4.5	26D	MK
1	CLASSROOM LOCK	JNR8808FL	626	YA
1	HS MORTISE CYL	1E74 CORMAX W/RING	26D	BE
2	KICKPLATE	6 x 34 x .050" x 3BE	32D	RO
1	OH STOPS	9-336	26D	RF
1	AFB	2805	26D	RO

HARDWARE SET 09

DOOR# A0B416, A0B509

3	HINGE	TA2714 4.5 X 4.5	26D	MK
1	HS MORTISE CYL	1E74 CORMAX	26D	BE
1	KEYPAD LOCK	KP-8278 LNB	26D	SA
1	MOP PLATE	6 X 34 X .050 X 3BE	32D	RO
1	WALL STOP	400	26D	RO
1	CLOSER	7500	689	NO

Hardware Set 69

DOOR# A0B400.1, A0B501.1, A0B504.1, A0B502, A0B514B

3	HINGE	T4A3786 4.5 X 4.5	26D	MK
		T4A3786 5 x 4.5 @ 4'-0" DOORS		
1	ELEC MORT LOCK CARD READER BY SECTION 28 0000	JNR8891FL x LBM x REX (secure)	626	YA
1	HS MORTISE CYL	1E74 CORMAX W/RING	26D	BE
1	CLOSER	7500	689	NO
1	KICK PLATE	6 x .050" x 3BE x LGTH TO FIT	32D	RO
1	WALL STOPS OMIT WHEN OH STOP IS USED	400	26D	RO
1	POWER TRANSFER	EL-EPTL / SC		SU
1	CONC.DOOR POS SWITCH	MSS-1C	628	SU
1	POWER SUPPLY NEEDS RACEWAY THRU DOOR	CENTRALIZED		
1	SMART PACK	2005M3		
1	DOOR CABLE	QC-C400P		
1	FRAMING CABLE	QC-C1500P		
1	WIRE DIAGRAM	BY 087100/PER EXAMPLE		
1	JUNCTION BOX	JB7		VD
1	SET SEALS	5050B		NG

HARDWARE SET 69.1

DOOR# A0B506.1

3	HINGE	T4A3786 4.5 X 4.5	26D	MK
		T4A3786 5 x 4.5 @ 4'-0" DOORS		
1	ELEC MORT LOCK CARD READER BY SECTION 28 0000	JNR8891FL x LBM x REX (secure)	626	YA
1	HS MORTISE CYL	1E74 CORMAX W/RING	26D	BE
1	CLOSER	CLP7500	689	NO
1	ARMOR PLATE	34 x .050" x 3BE x LGTH TO FIT	32D	RO
1	POWER TRANSFER	EL-EPTL / SC		SU
1	CONC.DOOR POS SWITCH	MSS-1C	628	SU
1	POWER SUPPLY NEEDS RACEWAY THRU DOOR	CENTRALIZED		
1	SMART PACK	2005M3		
1	DOOR CABLE	QC-C400P		
1	FRAMING CABLE	QC-C1500P		
1	WIRE DIAGRAM	BY 087100/PER EXAMPLE		
1	JUNCTION BOX	JB7		VD
1	SET SEALS	5050B		NG
1	AUTO DOOR BOTTOM	422N		NG

HARDWARE SET 69.2

DOOR# A0B421

3	HINGE	T4A3786 4.5 X 4.5	26D	MK
1	ELEC MORT LOCK CARD READER BY SECTION 28 0000	T4A3786 5 x 4.5 @ 4'-0" DOORS JNR8891FL x LBM x REX (secure)	626	YA
1	HS MORTISE CYL	1E74 CORMAX W/RING	26D	BE
1	AUTO OPERATOR	BY OTHERS		
1	ACTIVATION BOTTOM	BY OTHERS		
1	ARMOR PLATE	34" x .050" x 3BE x LGTH TO FIT	32D	RO
1	WALL STOPS	400	26D	RO
	OMIT WHEN OH STOP IS USED			
1	POWER TRANSFER	EL-EPTL / SC		SU
1	CONC.DOOR POS SWITCH	MSS-1C	628	SU
1	POWER SUPPLY	CENTRALIZED		
	NEEDS RACEWAY THRU DOOR			
1	SMART PACK	2005M3		
1	DOOR CABLE	QC-C400P		
1	FRAMING CABLE	QC-C1500P		
1	WIRE DIAGRAM	BY 087100/PER EXAMPLE		
1	JUNCTION BOX	JB7		VD
1	SET SEALS	5050B		NG
1	ELECT. STRIKE	1006CS		HE
1	AUTO DOOR BOTTOM	422N		NG

HARDWARE SET 69.3

DOOR# A0B427, A0B402, A0B505.1

6	HINGE	T4A3786 4.5 X 4.5	26D	MK
1	ELEC MORT LOCK CARD READER BY SECTION 28 0000	T4A3786 5 x 4.5 @ 4'-0" DOORS JNR8891FL x LBM x REX (secure)	626	YA
1	HS MORTISE CYL	1E74 CORMAX W/RING	26D	BE
2	CLOSER	7500	689	NO
2	ARMOR PLATE	34 x .050" x 3BE x LGTH TO FIT	32D	RO
2	WALL STOPS	400	26D	RO
	OMIT WHEN OH STOP IS USED			
1	POWER TRANSFER	EL-EPTL / SC		SU
1	CONC.DOOR POS SWITCH	MSS-1C	628	SU
1	POWER SUPPLY	CENTRALIZED		
	NEEDS RACEWAY THRU DOOR			
1	SMART PACK	2005M3		
1	DOOR CABLE	QC-C400P		
1	FRAMING CABLE	QC-C1500P		
1	WIRE DIAGRAM	BY 087100/PER EXAMPLE		
1	JUNCTION BOX	JB7		VD
1	CORD	2672		RO

1	SET AFB	2945	26D	RO
1	SET ASTRAGAL	672A (2 PC)		NG
1	SET SEALS	5050B		NG

HARDWARE SET 69.5

DOOR# A0B425.1

3	HINGE	T4A3786 4.5 X 4.5	26D	MK
1	ELEC MORT LOCK	T4A3786 5 x 4.5 @ 4'-0" DOORS		
	CARD READER BY SECTION 28 0000	JNR8891FL x LBM x REX (secure)	626	YA
1	HS MORTISE CYL	1E74 CORMAX W/RING	26D	BE
1	CLOSER	7500	689	NO
1	KICK PLATE	6 x .050" x 3BE x LGTH TO FIT	32D	RO
1	WALL STOPS	400	26D	RO
	OMIT WHEN OH STOP IS USED			
1	POWER TRANSFER	EL-EPTL / SC		SU
2	CONC.DOOR POS SWITCH	MSS-1C	628	SU
1	POWER SUPPLY	CENTRALIZED		
	NEEDS RACEWAY THRU DOOR			
1	SMART PACK	2005M3		
1	DOOR CABLE	QC-C400P		
1	FRAMING CABLE	QC-C1500P		
1	WIRE DIAGRAM	BY 087100/PER EXAMPLE		
1	JUNCTION BOX	JB7		VD
1	SET SEALS	5050B		NG
1	MAG LOCK	MM15		SE
1	2 DOOR INTERLOCK CONTROLLER	1410-2		ACSI
1	AUTO DOOR BOTTOM	422N		NG

NOTE: DOOR AB0425.1 INTERLOCKED TO A0B425.2 WITH MAG LOCK.

HARDWARE SET 69.6

DOOR# A0B425.2

3	HINGE	T4A3786 4.5 X 4.5	26D	MK
1	ELEC MORT LOCK	T4A3786 5 x 4.5 @ 4'-0" DOORS		
	CARD READER BY SECTION 28 0000	JNR8891FL x LBM x REX (secure)	626	YA
1	HS MORTISE CYL	1E74 CORMAX W/RING	26D	BE
1	AUTO OPERATOR	BY OTHERS		
1	ACTUATOR BOTTOM	BY OTHERS		
1	ARMOR PLATE	34" x .050" x 3BE x LGTH TO FIT	32D	RO
1	WALL STOPS	400	26D	RO
	OMIT WHEN OH STOP IS USED			
1	POWER TRANSFER	EL-EPTL / SC		SU
2	CONC.DOOR POS SWITCH	MSS-1C	628	SU
1	POWER SUPPLY	CENTRALIZED		
	NEEDS RACEWAY THRU DOOR			
1	SMART PACK	2005M3		
1	DOOR CABLE	QC-C400P		
1	FRAMING CABLE	QC-C1500P		
1	WIRE DIAGRAM	BY 087100/PER EXAMPLE		
1	JUNCTION BOX	JB7		VD
1	SET SEALS	5050B		NG
1	MAG LOCK	MM15		SE
1	AUTO DOOR BOTTOM	422N		NG
1	ELECT. STRIKE	1006CS		HE

NOTE: - DOOR A0B425.2 INTERLOCKED TO A0B425.1 WITH MAG LOCK.
 - AUTOMATIC OPERATOR TO BE ACTIVATED BY OUTSIDE CARD READER AND INSIDE ACTUATOR BOTTOM. IF DOOR A0B425.1 IS OPEN, INSIDE ACTIVATION BOTTOM AND OUTSIDE CARD READER TO BE DISABLE.

HARDWARE SET 69.7

DOOR# A0B423.1

3	HINGE	T4A3786 4.5 X 4.5	26D	MK
1	ELEC MORT LOCK	T4A3786 5 x 4.5 @ 4'-0" DOORS		
	CARD READER BY SECTION 28 0000	JNR8891FL x LBM x REX (secure)	626	YA
1	HS MORTISE CYL	1E74 CORMAX W/RING	26D	BE
1	AUTO OPERATOR	BY OTHERS		
1	ACTUATOR BOTTOM	BY OTHERS		
1	ARMOR PLATE	34" x .050" x 3BE x LGTH TO FIT	32D	RO
1	WALL STOPS	400	26D	RO
	OMIT WHEN OH STOP IS USED			
1	POWER TRANSFER	EL-EPTL / SC		SU
2	CONC.DOOR POS SWITCH	MSS-1C	628	SU
1	POWER SUPPLY	CENTRALIZED		
	NEEDS RACEWAY THRU DOOR			
1	SMART PACK	2005M3		
1	DOOR CABLE	QC-C400P		
1	FRAMING CABLE	QC-C1500P		
1	WIRE DIAGRAM	BY 087100/PER EXAMPLE		
1	JUNCTION BOX	JB7		VD
1	SET SEALS	5050B		NG
1	MAG LOCK	MM15		SE
1	AUTO DOOR BOTTOM	422N		NG
1	2 DOOR INTERLOCK CONTROLLER	1410.2		ACSI
1	ELECT. STRIKE	1006CS		HE

NOTE: - DOOR A0B423.1 INTERLOCKED TO A0B423.2 WITH MAG LOCK.
 - AUTOMATIC OPERATOR TO BE ACTIVATED BY OUTSIDE CARD READER AND INSIDE ACTUATOR BOTTOM. IF DOOR A0B423.2 IS OPEN, INSIDE ACTUATOR BOTTOM AND OUTSIDE CARD READER TO BE DISABLED.

HARDWARE SET 69.8

DOOR# A0B423.2

3	HINGE	T4A3786 4.5 X 4.5	26D	MK
1	PASSAGE	T4A3786 5 x 4.5 @ 4'-0" DOORS JNR8801FL	626	YA
1	AUTO OPERATOR	BY OTHERS		
1	ACTUATOR	BY OTHERS		
1	ARMOR PLATE	34" x .050" x 3BE x LGTH TO FIT	32D	RO
1	WALL STOPS	400	26D	RO
	OMIT WHEN OH STOP IS USED			
2	CONC.DOOR POS SWITCH	MSS-1C	628	SU
1	WIRE DIAGRAM	BY 087100/PER EXAMPLE		
1	JUNCTION BOX	JB7		VD
1	SET SEALS	5050B		NG
1	MAG LOCK	MM15		SE
1	AUTO DOOR BOTTOM	422N		NG
1	ELECT. STRIKE	1006CS		HE

NOTE: - DOOR A0B423.2 INTERLOCKED TO A0B423.1 WITH MAG LOCK.
- AUTOMATIC OPERATOR TO BE ACTIVATED BY OUTSIDE ACTUATOR BOTTOM AND INSIDE ACTUATOR BOTTOM. IF DOOR A0B425.1 IS OPEN INSIDE ACTUATOR BOTTOM AND OUTSIDE ACTUATOR BOTTOM TO BE DISABLED.

HARDWARE SET 82.1

DOOR# A0B503

3	HINGE	T4A3786 4.5 X 4.5	26D	MK
1	ELEC MORT LOCK	V21 PHR NAC 82281 LNB	626	SA
1	HS MORTISE CYL	1E74 CORMAX W/RING	26D	BE
1	CLOSER	7500	689	YA
1	KICK PLATE	6 x 34 x .050" x 3BE	32D	RO
1	WALL STOPS	400	26D	RO
1	POWER TRANSFER	EL-EPT / SC		SU
1	CONC.DOOR POS SWITCH	MSS-1C	628	SU
1	POWER SUPPLY	CENTRALIZED		
	CARD READER BY SECTION 28 0000			
	NEEDS RACEWAY THRU DOOR			
1	SMART PACK	2005M3		HES
1	DOOR CABLE	QC-C300P		
1	FRAMING CABLE	QC-C1500P		
1	WIRE DIAGRAM	BY 087100/PER EXAMPLE		
1	JUNCTION BOX	JB7		VD
1	SET SEALS	5050B		NG

NOTE: LOCK WITH CARD READER SHUNT WHEN DEADBOLT ACTIVATED
LOCK WITH OUTSIDE INDICATOR

HARDWARE SET 115

DOOR# A0B507.1, A0B507.2, A0B506.2, A0B505.2

2	CONT SW CL HING	HG329 x 83-1/8"	32D	MA
4	SHIMS	CHS-2 7'0"		MA
2	MOP PLATE	6 x .050" x 3BE x LGTH TO FIT	32D	RO
2	ARMOR PLATE	34 x .050" x 3BE x LGTH TO FIT	32D	RO
2	POWER TRANSFER	EL-EPTL / SC		SU
1	WIRE DIAGRAM	BY 087100/PER EXAMPLE		
2	AUTO OPERATORS	BY OTHERS		
2	PUSH PLATES	8X16	32D	RO
2	PULL PLATES	B156 X 70C	32D	RO
1	AUTO DOOR BOTTOM	422N		NG
2	2 PIECE ASTRAGAL SEAL	140SA		NG
1	SET SEALS	5050B		NG

HARDWARE SET 251.2

DOOR# A0B501.2, A0B504.2

3	HINGE	T4A3786 4.5 X 4.5	26D	MK
1	PASSAGE SET	JNR8801FL	626	YA
1	CLOSER	CLP 7500	689	NO
1	KICK PLATE	6 X 34 X .050" X 3BE	32D	RO

HARDWARE SET 301

DOOR# A0B400D.1

1	SET SLIDING DR TRACK	CCSF-2-998-CA X 72" 1 DR KIT		CR
1	SLIDING DR LOCK	XGT 205 PD9550 W/WS-90	32D	IN
1	CYLINDER	1E74 CORMAX W/RING	26D	BE

END OF DOOR HARDWARE SCHEDULE

SECTION 10 2213 - WIRE MESH PARTITIONS

PART 1 - GENERAL

1.1 SUMMARY

- A. Section includes:
 - 1. Wire mesh partition including mesh, framing, shoes, and accessories.
 - 2. Wire mesh door, frame and hardware.
- B. Products installed but not supplied under this Section: Division 08 Section – Door Hardware: Cylinder lock for mesh partition door.

1.2 SUBMITTALS

- A. Product Data: For each type of product.
- B. Shop drawings: Submit copies indicating layout and details of fabrication and installation.
- C. Samples: For units with factory-applied color finishes.

1.3 QUALITY ASSURANCE

- A. Welding Qualifications: Qualify procedures and personnel according to the following:
 - 1. AWS D1.1, "Structural Welding Code - Steel."
 - 2. AWS D1.3, "Structural Welding Code - Sheet Steel."

1.4 FIELD CONDITIONS

- A. Field Measurements: Verify actual dimensions of construction contiguous with wire mesh storage lockers by field measurements before fabrication.

PART 2 - PRODUCTS

2.1 PRODUCT REQUIREMENTS

- A. Subject to compliance with requirements, manufacturers offering products that may be incorporated in the Work include but not limited to:
 - 1. Acorn Wire and Iron Works Co.
 - 2. Indiana Wire Products, Inc.
 - 3. WireCrafters
 - 4. Architects Sales, Inc; Global Industries

2.2 MATERIALS

- A. Steel Wire: ASTM A10..
 - 1. Galvanized Steel Wire: ASTM A 641
- B. Steel Channels, Angles, Plates, and Bars: ASTM A 36
- C. Steel Sheet: ASTM A 1008.
 - 1. Galvanized Steel Sheet: Commercial-quality, hot-dip-coated steel sheet, ASTM A 653, with G60 coating.
- D. Cold-Rolled Steel Channels: Formed from steel sheet.
- E. Square Steel Tubing: Cold-formed structural steel tubing, ASTM A 500.

2.3 HEAVY-DUTY MESH PARTITIONS

- A. Partitions: Full height floor to ceiling with approximately 3-inch sweep space between floor and bottom channel, top channel 4-inches below ceiling.
- B. Mesh: 3/16-inch diameter, lock crimped steel wire, woven into 2 inch diamond mesh, securely clinched to frame members.
- C. Frames: Provide cutouts for pipes, ducts, beams, and other items shown or necessary for partition installation. finish edges of cutouts to provide a neat, protective edge.
 - 1. Frame Members: 1-1/2 by 3/4 inch cold-rolled steel channels with 3/8 inch diameter bolt holes approximately 18 inches o.c.
 - 2. Horizontal Reinforcing members: 1-1/2 by 3/4 by 1/8 inch cold rolled steel channels with wire woven through or two 1 by 2 inch steel channels bolted or riveted toe to toe through mesh, and secured to vertical members.
- D. Stiffening Bars: Provide flat steel bar stiffener posts between abutting panel frames. Size as recommended by Partition manufacturer for partition height required. Increase size of stiffening bars, if required , to maintain partition rigidity.
- E. Top Capping Bar: 3-inch by 4.1 lb. steel channels, secured to top framing member with 1/4 inch diameter “U” bolts spaced not more than 28 inches o.c.
- F. Corner Posts: 2 by 2 by 1/8-inch steel angles with floor shoe and 3/8-inch diameter holes to align bolt holes in vertical frame members.
- G. Line Posts: Where 3- or 4-way intersections occur, use 2 by 2-inch tubular steel posts with floor shoe and 3/8 inch diameter bolt holes aligned for bolting to adjacent panels.
 - 1. For other than 90 degree intersections, use manufacturer’s recommended tubular steel corner posts and installation accessories.
- H.

- I. Fasteners for Attaching Metal Framing to concrete floor structure above:
 - 1. For post-tensioned concrete, obtain Structural Engineer's written approval for all proposed anchors in post-tensioned concrete prior to installation.
- J. Panel-to-Panel Fasteners: Manufacturer's standard stainless-steel bolts, nuts, and washers.
 - 1. Provide bolts, hardware, and accessories for complete installation.
- K. Floor Shoes: Cast metal, sized to suit vertical framing and to provide approximately 3 inches of clear space between floor and bottom horizontal frame members. Furnish units with set screws for leveling adjustment.
- L. Sheet Metal Base: Panels of 0.0598 inch thick steel sheets, welded or bolted to frames.
- M. Doors: Manufacturer's standard heavy duty mesh door and frame to match panel units.
 - 1. Size: as indicated on Drawings.
 - 2. Hardware:
 - a. Hinges: 1-1/2 pair/door - manufacturer's standards; riveted or welded to door and frame.
 - b. Mortise-type cylinder lock operated by key outside with recessed knob inside. Cylinder as supplied in Section 08700.
 - c. Align bottom of door with adjacent panels.
- N. Provide bolts, hardware, and accessories for complete installation.

2.4 FABRICATION

- A. General: Fabricate wire mesh storage lockers from components of sizes not less than those indicated. Use larger size components as recommended by wire mesh manufacturer. Furnish bolts, hardware, and accessories required for complete installation with manufacturer's standard finishes.
 - 1. Fabricate wire mesh storage lockers to be readily disassembled.
 - 2. Welding: Weld corner joints of framing and grind smooth, leaving no evidence of joint.
- B. Finish on wire and other exposed metal:
 - 1. Powder-Coat Finish: Immediately after cleaning and pretreating, apply manufacturer's standard baked-on powder-coat finish, suitable for use indicated, with a minimum dry film thickness of **2 mils**.
 - 2. Color as selected by Architect.

PART 3 - EXECUTION

3.1 COORDINATION

- A. Coordinate and furnish anchorages, setting drawings, diagrams, templates, instructions, and directions for installing anchorages, including concrete inserts, sleeves, anchor bolts, and miscellaneous items having integral anchors embedded in concrete or masonry construction. Coordinate delivery of such items to Project site.

3.2 INSTALLATION

- A. Install partitions plumb, rigid, properly aligned, and securely fastened in place, in accordance with manufacturer's recommendation and approved shop drawings.
 - 1. Provide additional field bracing as shown or necessary for rigid, secure installation. Installer to provide additional clips and bracing as required.
- B. Install door and hardware; hang door plumb and true and adjust for perfect operation.
- C. Install lock cylinder provided in Section 08 7100 into mortised lockset.

3.3 ADJUSTMENT AND CLEANING


- A. Adjust doors and windows for smooth operation with binding.
- B. Touch up damaged finish after completing installation using field-applied paint to match color of shop applied finish.

END OF SECTION 10 2213

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Drawing Issue:

RECORD DRAWINGS


No.	Date	Description
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2	11.03.10	ADDENDUM NO. 2
3	01.31.11	ASI 009

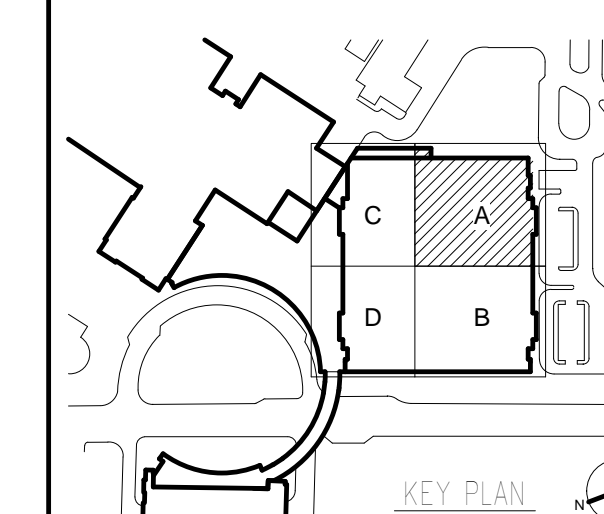Drawing Title:

**BASEMENT LEVEL
EQUIPMENT PLAN
AREA-A**

Job Number:	10247.40
File:	
Scale:	As indicated
Date:	10.11.10


EQ20BA

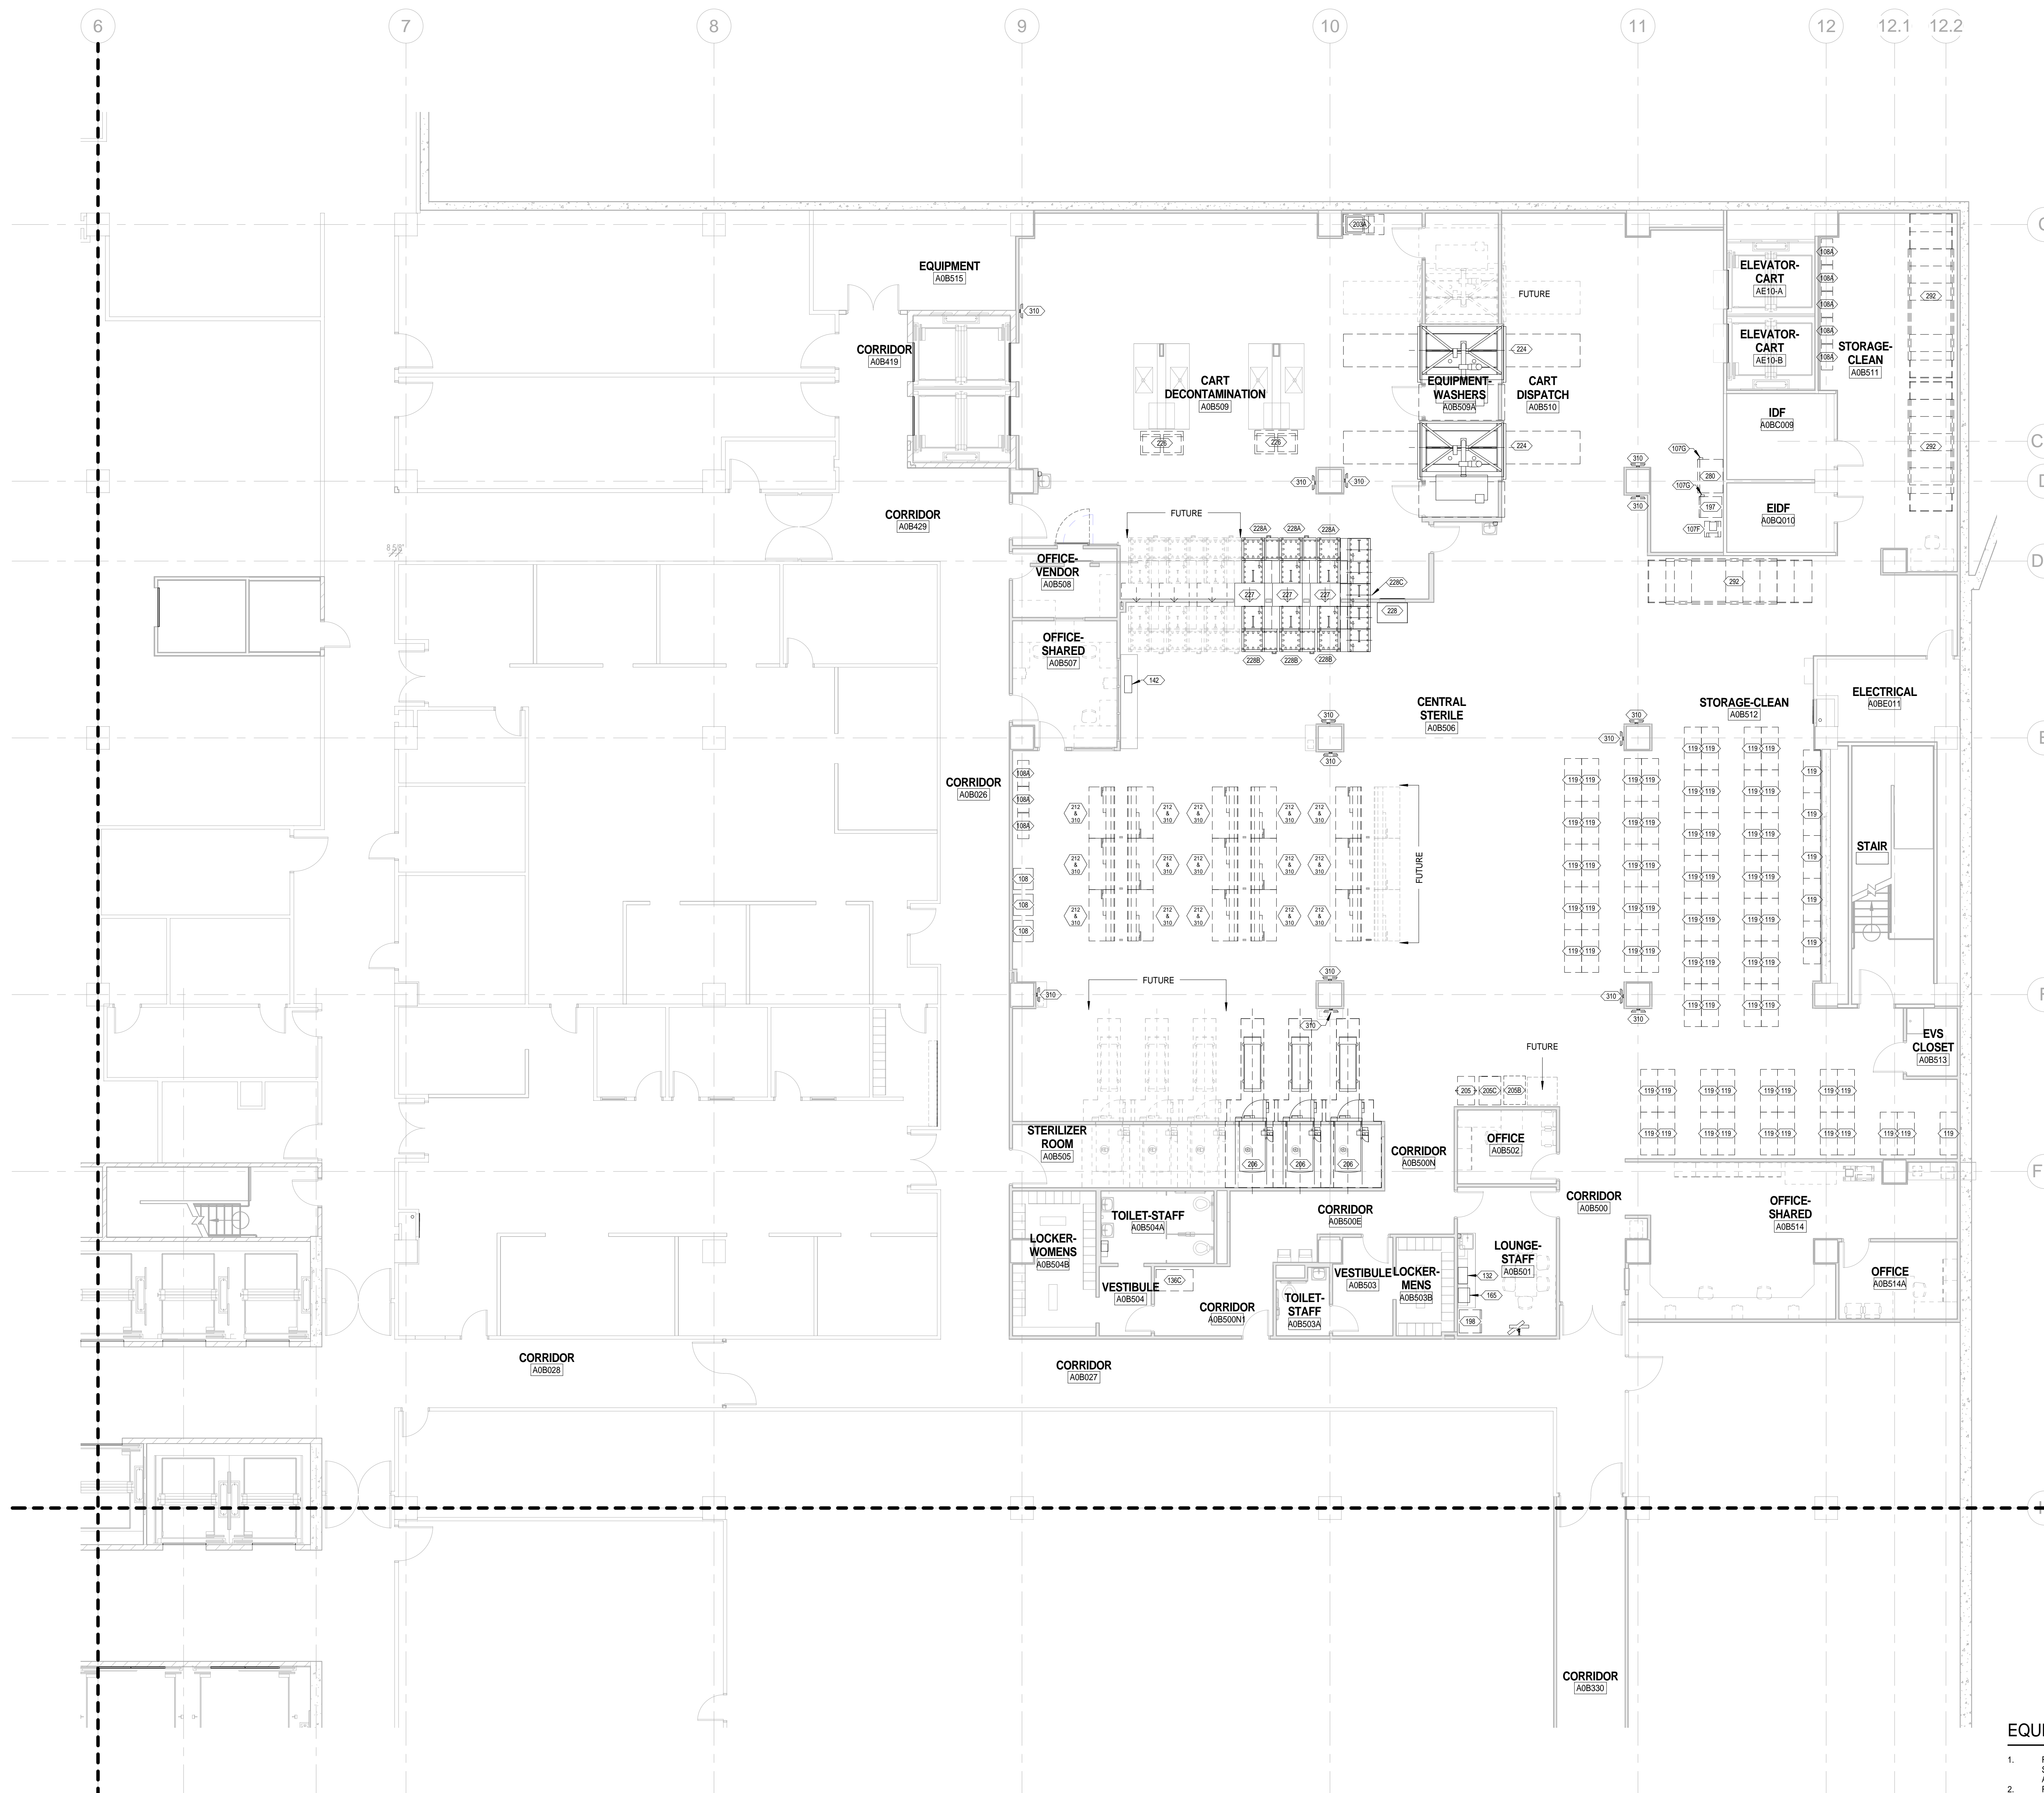

EQUIPMENT PLAN GENERAL NOTES

- REFER TO THE PROJECT MANUAL FOR EQUIPMENT DESCRIPTIONS, SCHEDULES, INCLUDING CONTRACTOR, VENDOR/OWNER RESPONSIBILITIES, AND REQUIRED INFRASTRUCTURE.
- REFER TO VENDOR DRAWINGS FOR MAJOR MEDICAL EQUIPMENT PLACEMENT AND ADDITIONAL INSTALLATION INFORMATION.
- MAINTAIN WALL AND FLOOR FIRE RATINGS FOR PENETRATIONS.
- PROVIDE FIRE RETARDANT BLOCKING FOR WALL MOUNTED EQUIPMENT.
- REFER TO INTERIOR ELEVATIONS FOR WALL MOUNTED EQUIPMENT.

1 BASEMENT LEVEL FLOOR PLAN
EQ20BA SCALE: 1/8" = 1'-0"

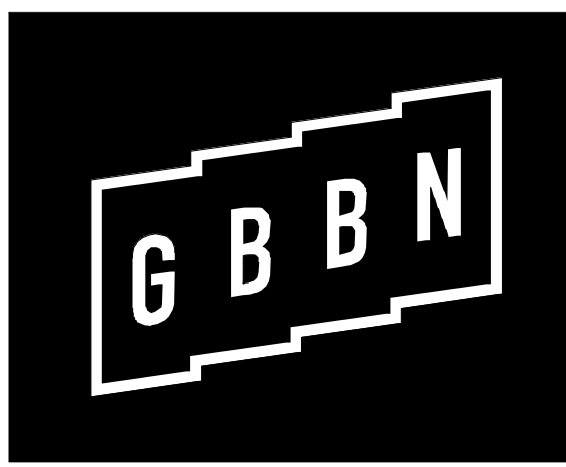

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Renovate / Upgrade
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Facilities
Pavilion A Level B
Project Number: 2239.77

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DRAWING ISSUE

CONTRACT DOCUMENTS

NO.	DATE	DESCRIPTION
1	05.20.22	CD/BID DOCUMENTS BP#2
2	09.20.22	BP2 ADDENDUM 6

DRAWING TITLE

**LEVEL B DEMOLITION
PLAN - AREA A PHASE 2**

SEAL



JOB NUMBER

14590.01

D10B-A.2

05/20/2022

GENERAL NOTES: DEMOLITION FLOOR PLAN

- A. PHASING**
 - DRAWING DEPICTS COMPLETED DEMOLITION SCOPE. REFER TO PHASING PLANS FOR GENERAL DESCRIPTION OF PHASING.
- B. DEMOLITION PROCEDURES**
 - REFER TO THE PROJECT MANUAL FOR GENERAL DEMOLITION PROCEDURES, SALVAGING, PROTECTION, COORDINATION WITH NEW WORK, TRAFFIC AND CIRCULATION, UTILITIES, ACCESS AND TEMPORARY CONTROLS, FACILITIES, POLLUTION CONTROLS, SHORING, CUTTING AND PATCHING, LIFE SAFETY PROCEDURES, AND OTHER DEMOLITION REQUIREMENTS DESCRIBED THEREIN.
- C. COORDINATION**
 - COORDINATE DEMOLITION INFORMATION SHOWN ON THIS PLAN WITH OTHER DEMOLITION TRADES AND WITH NEW WORK INDICATED ON OTHER DRAWINGS.
- D. ARCHITECTURAL DEMOLITION**
 - THE INTENT OF THIS PLAN IS TO DESCRIBE GENERAL AREAS OF DEMOLITION.
 - WHERE INTERIOR SPACES ARE SHOWN WITH DASHED LINES AND EXCEPT AS INDICATED OTHERWISE, REMOVE AND DISPOSE OF THE FOLLOWING:
 - NON-LOAD BEARING PARTITIONS, WALL-MOUNTED ITEMS, DOORS AND FRAMES, FLOORING, FINISHED CEILINGS, CEILING SUSPENSION SYSTEMS, CEILING MOUNTED DEVICES, CASEWORK, MILLWORK, AND TRIM.
- E. MECHANICAL, ELECTRICAL, PLUMBING, FIRE PROTECTION DEMOLITION**
 - REFER TO MECHANICAL, ELECTRICAL, PLUMBING AND FIRE PROTECTION DRAWINGS FOR ADDITIONAL DEMOLITION REQUIREMENTS. DISCONNECT AND CAP UTILITIES AS INDICATED THEREIN.
- F. WALL MOUNTED ITEMS**
 - UNLESS INDICATED OTHERWISE, REMOVE AND DISPOSE OF WALL-MOUNTED AND COLUMN-MOUNTED ITEMS WHERE WALLS AND COLUMNS ARE TO REMAIN.
 - COORDINATE WITH MECHANICAL, ELECTRICAL, PLUMBING AND FIRE PROTECTION DRAWINGS.
- G. HAZARDOUS MATERIALS**
 - IN THE EVENT A CONTRACTOR ENCOUNTERS, ON THE SITE, MATERIAL REASONABLY BELIEVED TO BE ASBESTOS OR POLYCHLORINATED BI-PHENYL (PCB) WHICH HAS NOT BEEN RENDERED HARMLESS, THE CONTRACTOR SHALL IMMEDIATELY STOP WORK IN THE AREA AFFECTED AND REPORT THE CONDITION TO THE OWNER, ARCHITECT, AND CONSTRUCTION MANAGER IN WRITING. REFER ALSO TO THE GENERAL CONDITIONS OF THE CONTRACT.
- H. FLOOR EXCAVATION FOR UNDERSLAB WORK**
 - EXCAVATION SCOPE SHOWN IS APPROXIMATE. REFER TO MECHANICAL, PLUMBING, AND ELECTRICAL DRAWINGS FOR EXACT LOCATIONS OF NEW WORK. REFER TO STRUCTURAL DRAWINGS FOR REINFORCEMENT DETAILS.



- EQUIPMENT**
 - DISASSEMBLY AND REMOVAL BY OTHERS. MEP TO DISCONNECT AND REMOVE PIPING, DUCTWORK, CONDUIT, ETC. PER PLANS.

DEMOLITION GRAPHIC KEY


- REMOVE WALL / PARTITION FULL HEIGHT TO STRUCTURE
- REMOVE DOOR. REFER TO DOOR SCHEDULE FOR INSTANCES OF REUSING THE FRAME AND/OR SALVAGING HARDWARE.
- REMOVE WINDOW - SASH AND FRAME
- SLAB TO BE REMOVED AND REPLACED TO FACILITATE CONSTRUCTION OF UTILITIES. AREAS ARE DIAGRAMMATIC. REFER TO MEP DRAWINGS FOR EXACT SIZE AND LOCATION. REFER TO STRUCTURAL DRAWINGS FOR DETAIL.
- WALL / PARTITION TO REMAIN
- DOOR TO REMAIN
- AREA NOT IN SCOPE

HEX (D) DEMOLITION PLAN NOTES

KEYNOTE	DESCRIPTION
D1	REMOVE EXISTING WALL FOR NEW OPENING
D15	REMOVE SLAB FOR INSTALLATION OF PIT-MOUNTED EQUIPMENT
D18	TEMPORARY WALL SHOWN FOR REFERENCE. CM TO CONTROL TEMPORARY BARRIER LOCATIONS. WORK BY GENERAL TRADES.
D19	REMOVE AND DISPOSE OF OVERHEAD DOOR AND HARDWARE
D22	REMOVE EXISTING FULL HEIGHT FITSACK WALL
D24	EXISTING FURNITURE TO BE REMOVED BY OWNER
D25	EXISTING MEDICAL WORK BENCH CONTRACTOR TO BE DISASSEMBLED AND TRANSPORT TO PAV A LOADING DOCK. REFER TO MEP PLANS FOR SYSTEMS DISCONNECTS.
D27	EXISTING MEDICAL EQUIPMENT. CONTRACTOR TO MAKE SAFE FOR REMOVAL. REFER TO MEP PLANS FOR SYSTEMS DISCONNECT

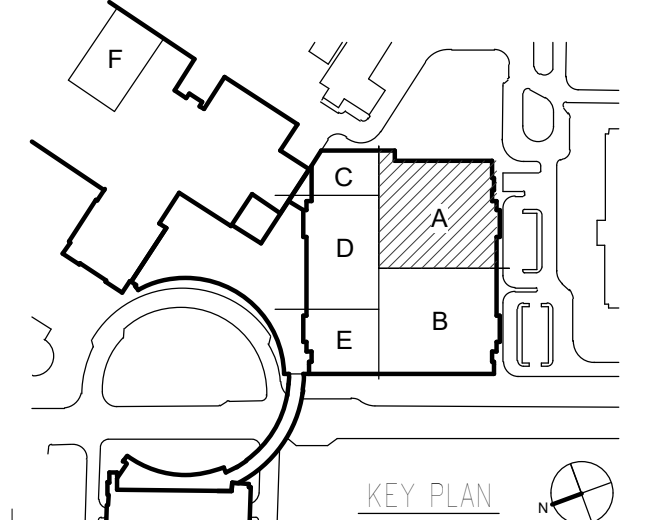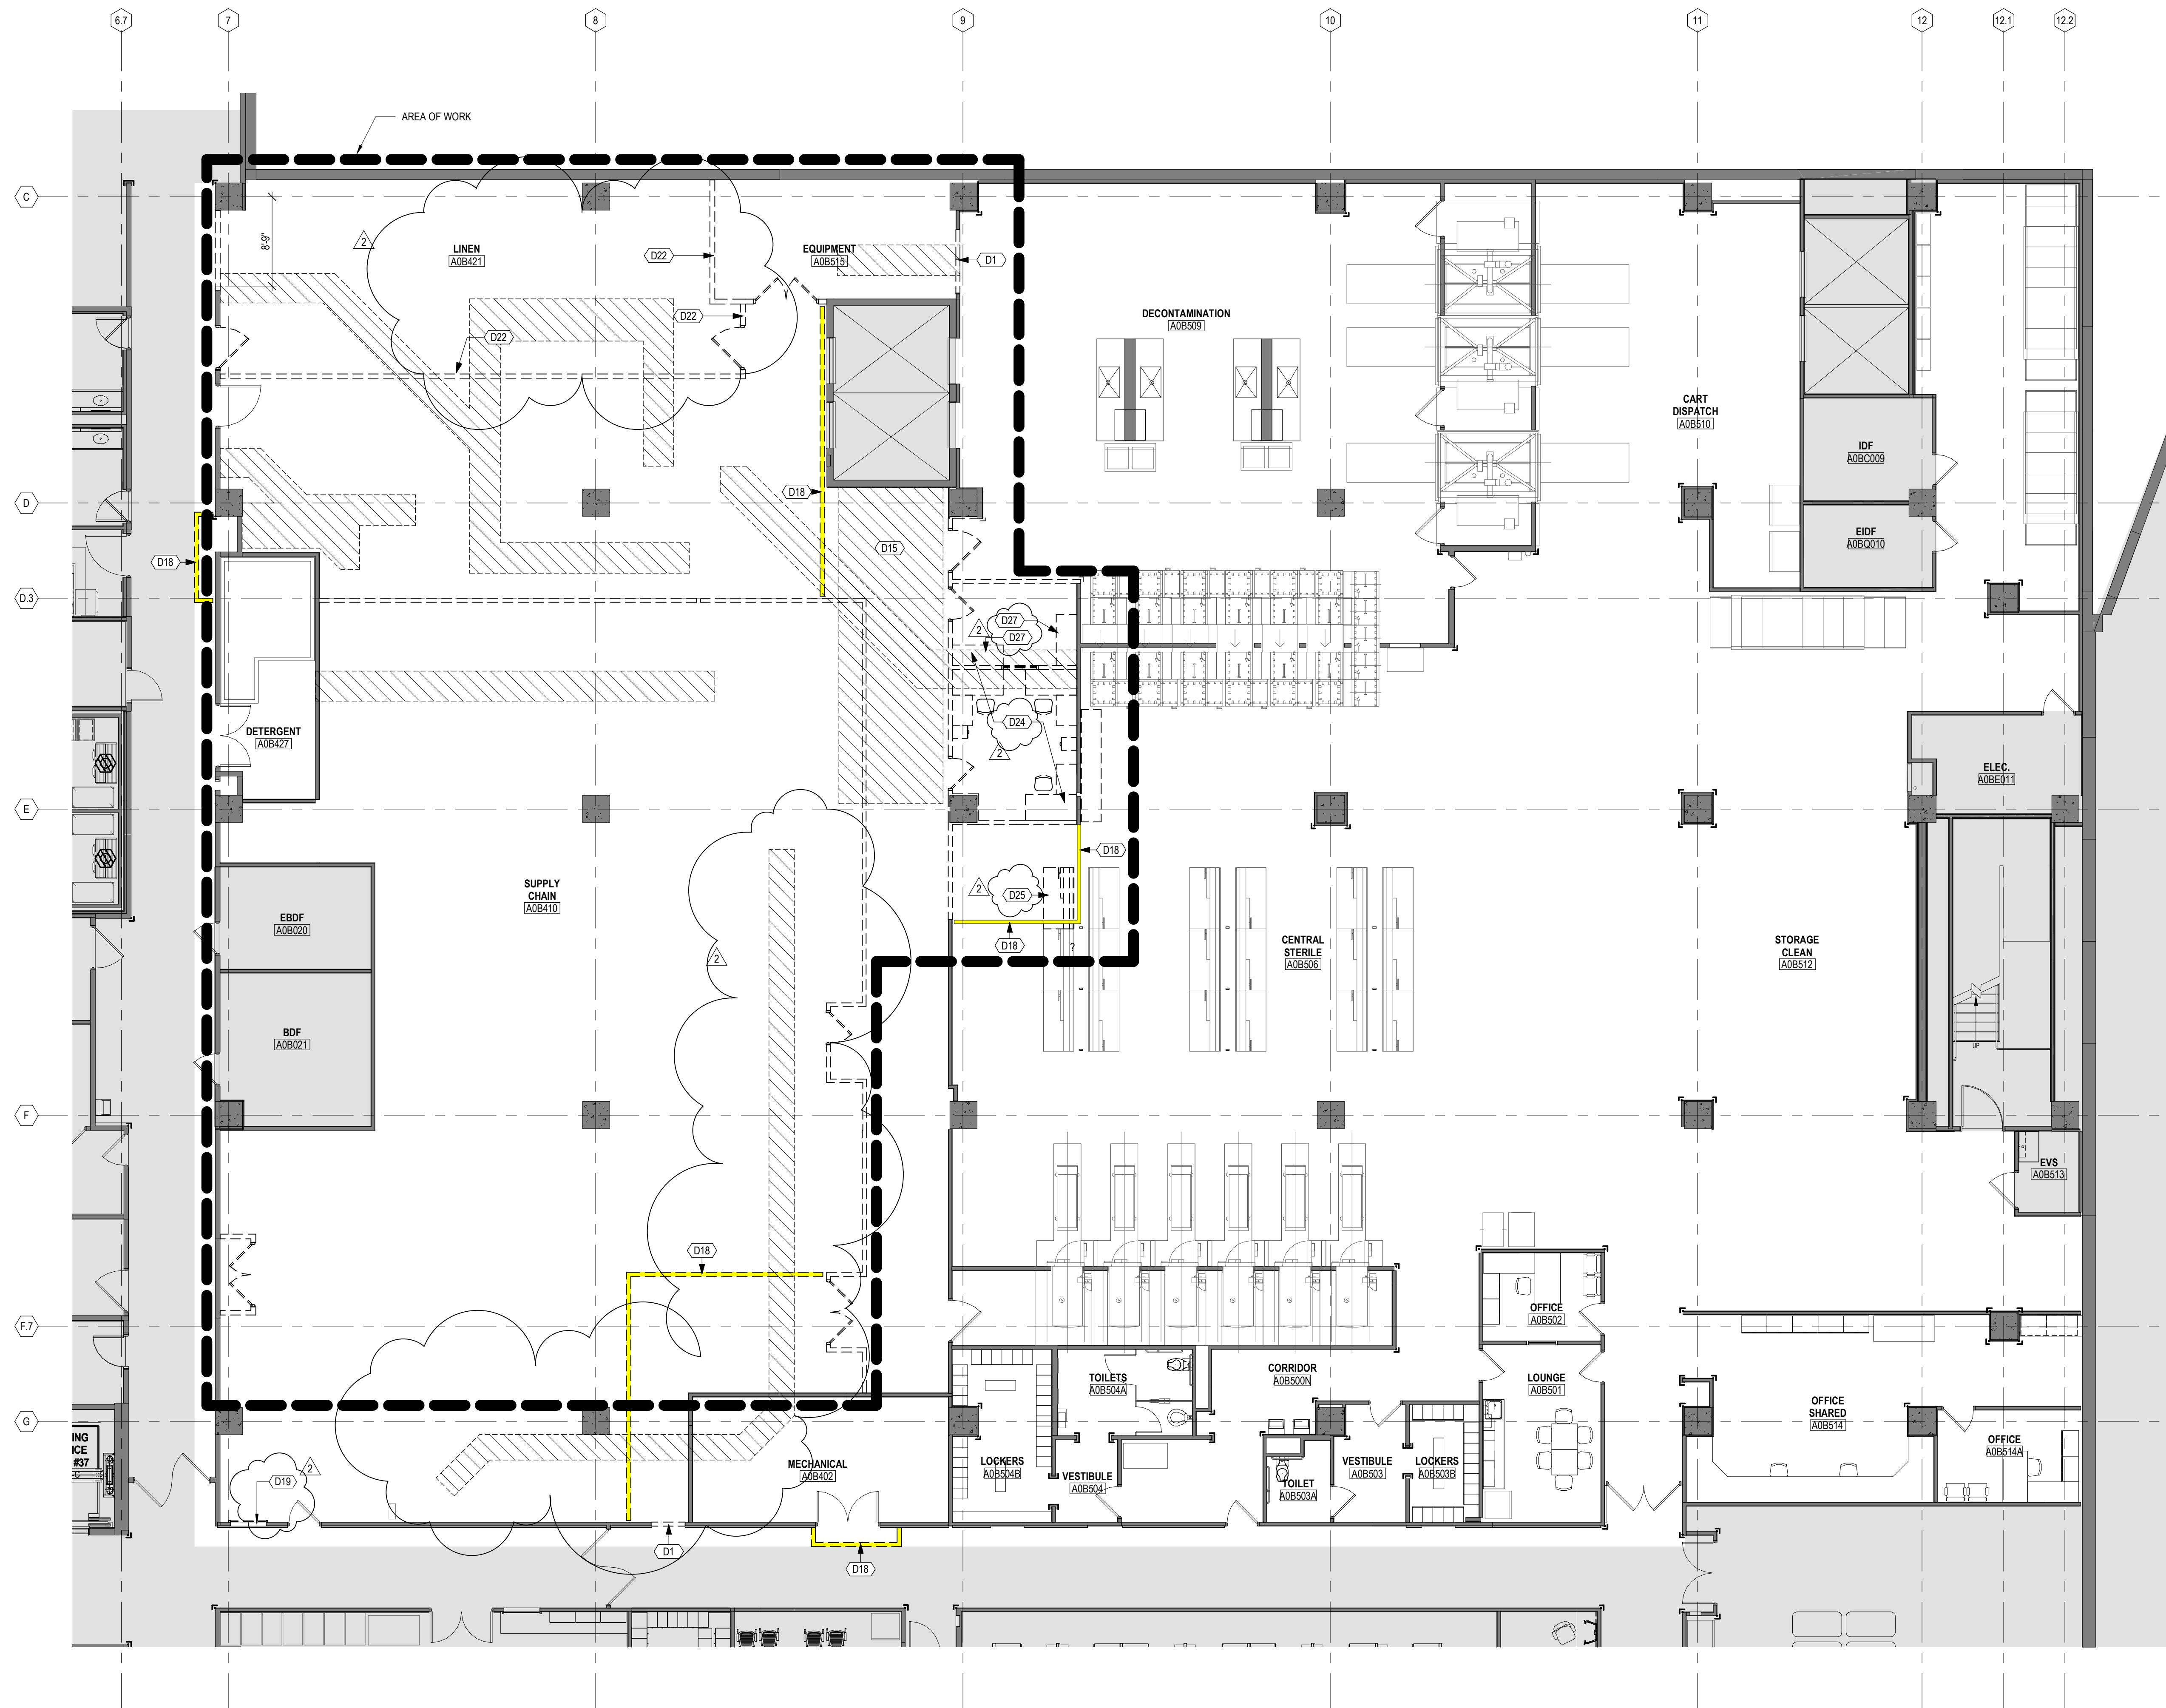

LEVEL B DEMOLITION PLAN AREA A PHASE 2
SCALE: 1/8" = 1'-0"

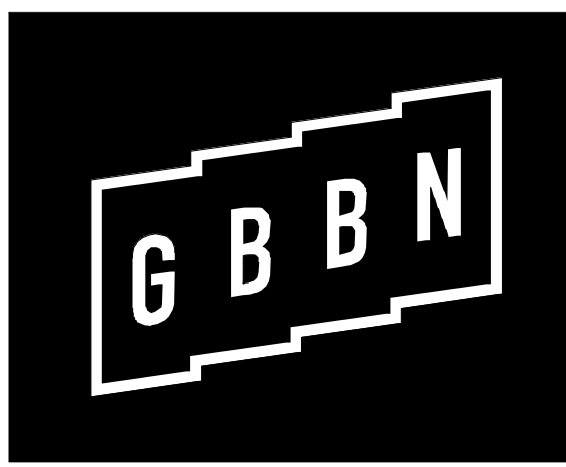

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CONTRACT DOCUMENTS

NO.	DATE	DESCRIPTION
1	05/20/22	CD/BD DOCUMENTS #P#2
2	09/20/22	BP2 ADDENDUM 6

DRAWING TITLE

**LEVEL B DEMOLITION
PLAN - AREA A PHASE 3**

SEAL



JOB NUMBER

14590.01

D10B-A.3

05/20/2022

GENERAL NOTES: DEMOLITION FLOOR PLAN



- A. PHASING**
 - DRAWING DEPICTS COMPLETED DEMOLITION SCOPE. REFER TO PHASING PLANS FOR GENERAL DESCRIPTION OF PHASING.
- B. DEMOLITION PROCEDURES**
 - REFER TO THE PROJECT MANUAL FOR GENERAL DEMOLITION PROCEDURES, SALVAGING, PROTECTION, COORDINATION WITH NEW WORK, TRAFFIC AND CIRCULATION, UTILITIES, ACCESS AND TEMPORARY CONTROLS, FACILITIES, POLLUTION CONTROLS, SHORING, CUTTING AND PATCHING, LIFE SAFETY PROCEDURES, AND OTHER DEMOLITION REQUIREMENTS DESCRIBED THEREIN.
- C. COORDINATION**
 - COORDINATE DEMOLITION INFORMATION SHOWN ON THIS PLAN WITH OTHER DEMOLITION TRADES AND WITH NEW WORK INDICATED ON OTHER DRAWINGS.
- D. ARCHITECTURAL DEMOLITION**
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- E. MECHANICAL, ELECTRICAL, PLUMBING, FIRE PROTECTION DEMOLITION**
 - REFER TO MECHANICAL, ELECTRICAL, PLUMBING AND FIRE PROTECTION DRAWINGS FOR ADDITIONAL DEMOLITION REQUIREMENTS. DISCONNECT AND CAP UTILITIES AS INDICATED THEREIN.
- F. WALL MOUNTED ITEMS**
 - UNLESS INDICATED OTHERWISE, REMOVE AND DISPOSE OF WALL-MOUNTED AND COLUMN-MOUNTED ITEMS WHERE WALLS AND COLUMNS ARE TO REMAIN.
 - COORDINATE WITH MECHANICAL, ELECTRICAL, PLUMBING AND FIRE PROTECTION DRAWINGS.
- G. HAZARDOUS MATERIALS**
 - IN THE EVENT A CONTRACTOR ENCOUNTERS, ON THE SITE, MATERIAL REASONABLY BELIEVED TO BE ASBESTOS OR POLYCHLORINATED BIPHENYL (PCB) WHICH HAS NOT BEEN RENDERED HARMLESS, THE CONTRACTOR SHALL IMMEDIATELY STOP WORK IN THE AREA AFFECTED AND REPORT THE CONDITION TO THE OWNER, ARCHITECT, AND CONSTRUCTION MANAGER IN WRITING. REFER ALSO TO THE GENERAL CONDITIONS OF THE CONTRACT.
- H. FLOOR EXCAVATION FOR UNDERSLAB WORK**
 - EXCAVATION SCOPE SHOWN IS APPROXIMATE. REFER TO MECHANICAL, PLUMBING, AND ELECTRICAL DRAWINGS FOR EXACT LOCATION OF NEW WORK. REFER TO STRUCTURAL DRAWINGS FOR REINFORCING BARS.
- I. EQUIPMENT**
 - DISASSEMBLY AND REMOVAL BY OTHERS. MEP TO DISCONNECT AND REMOVE PIPING, DUCTWORK, CONDUIT, ETC. PER PLANS.

DEMOLITION GRAPHIC KEY

- REMOVE WALL / PARTITION FULL HEIGHT TO STRUCTURE
- REMOVE DOOR. REFER TO DOOR SCHEDULE FOR INSTANCES OF REUSING THE FRAME AND/OR SALVAGING HARDWARE.
- REMOVE WINDOW - SASH AND FRAME
- SLAB TO BE REMOVED AND REPLACED TO FACILITATE CONSTRUCTION OF UTILITIES. AREAS ARE DIAGRAMMATIC. REFER TO MEP DRAWINGS FOR EXACT SIZE AND LOCATION. REFER TO STRUCTURAL DRAWINGS FOR DETAIL.
- WALL / PARTITION TO REMAIN
- DOOR TO REMAIN
- AREA NOT IN SCOPE

HEX (D) DEMOLITION PLAN NOTES


KEYNOTE	DESCRIPTION
D6	REMOVE AND REPLACE EXISTING CEILING AND LIGHTING; GRID AND SPRINKLER HEADS TO REMAIN AND BE REUSED. REFER TO MEP DRAWINGS.
D11	REMOVE EXISTING FLOORING AND ASSOCIATED ADHESIVES.
D18	TEMPORARY WALL SHOWN FOR REFERENCE. CM TO CONTROL TEMPORARY BARRIERS LOCATIONS. WORK BY GENERAL TRADES.
D21	REMOVE AND DISPOSE OF EXISTING FLOOR DRAIN AND CAP PIPE.
D26	EXISTING FURNITURE TO BE REMOVED BY OWNER.
D27	EXISTING MEDICAL EQUIPMENT. CONTRACTOR TO MAKE SAFE FOR REMOVAL. REFER TO TRIM PLANS FOR PARTIAL DISCONNECT.
D28	EXISTING SINK AND ASSOCIATED WORK BENCH TO BE DISASSEMBLED AND REMOVED BY OTHERS. REFER TO MEP PLANS FOR SYSTEM DISCONNECT.

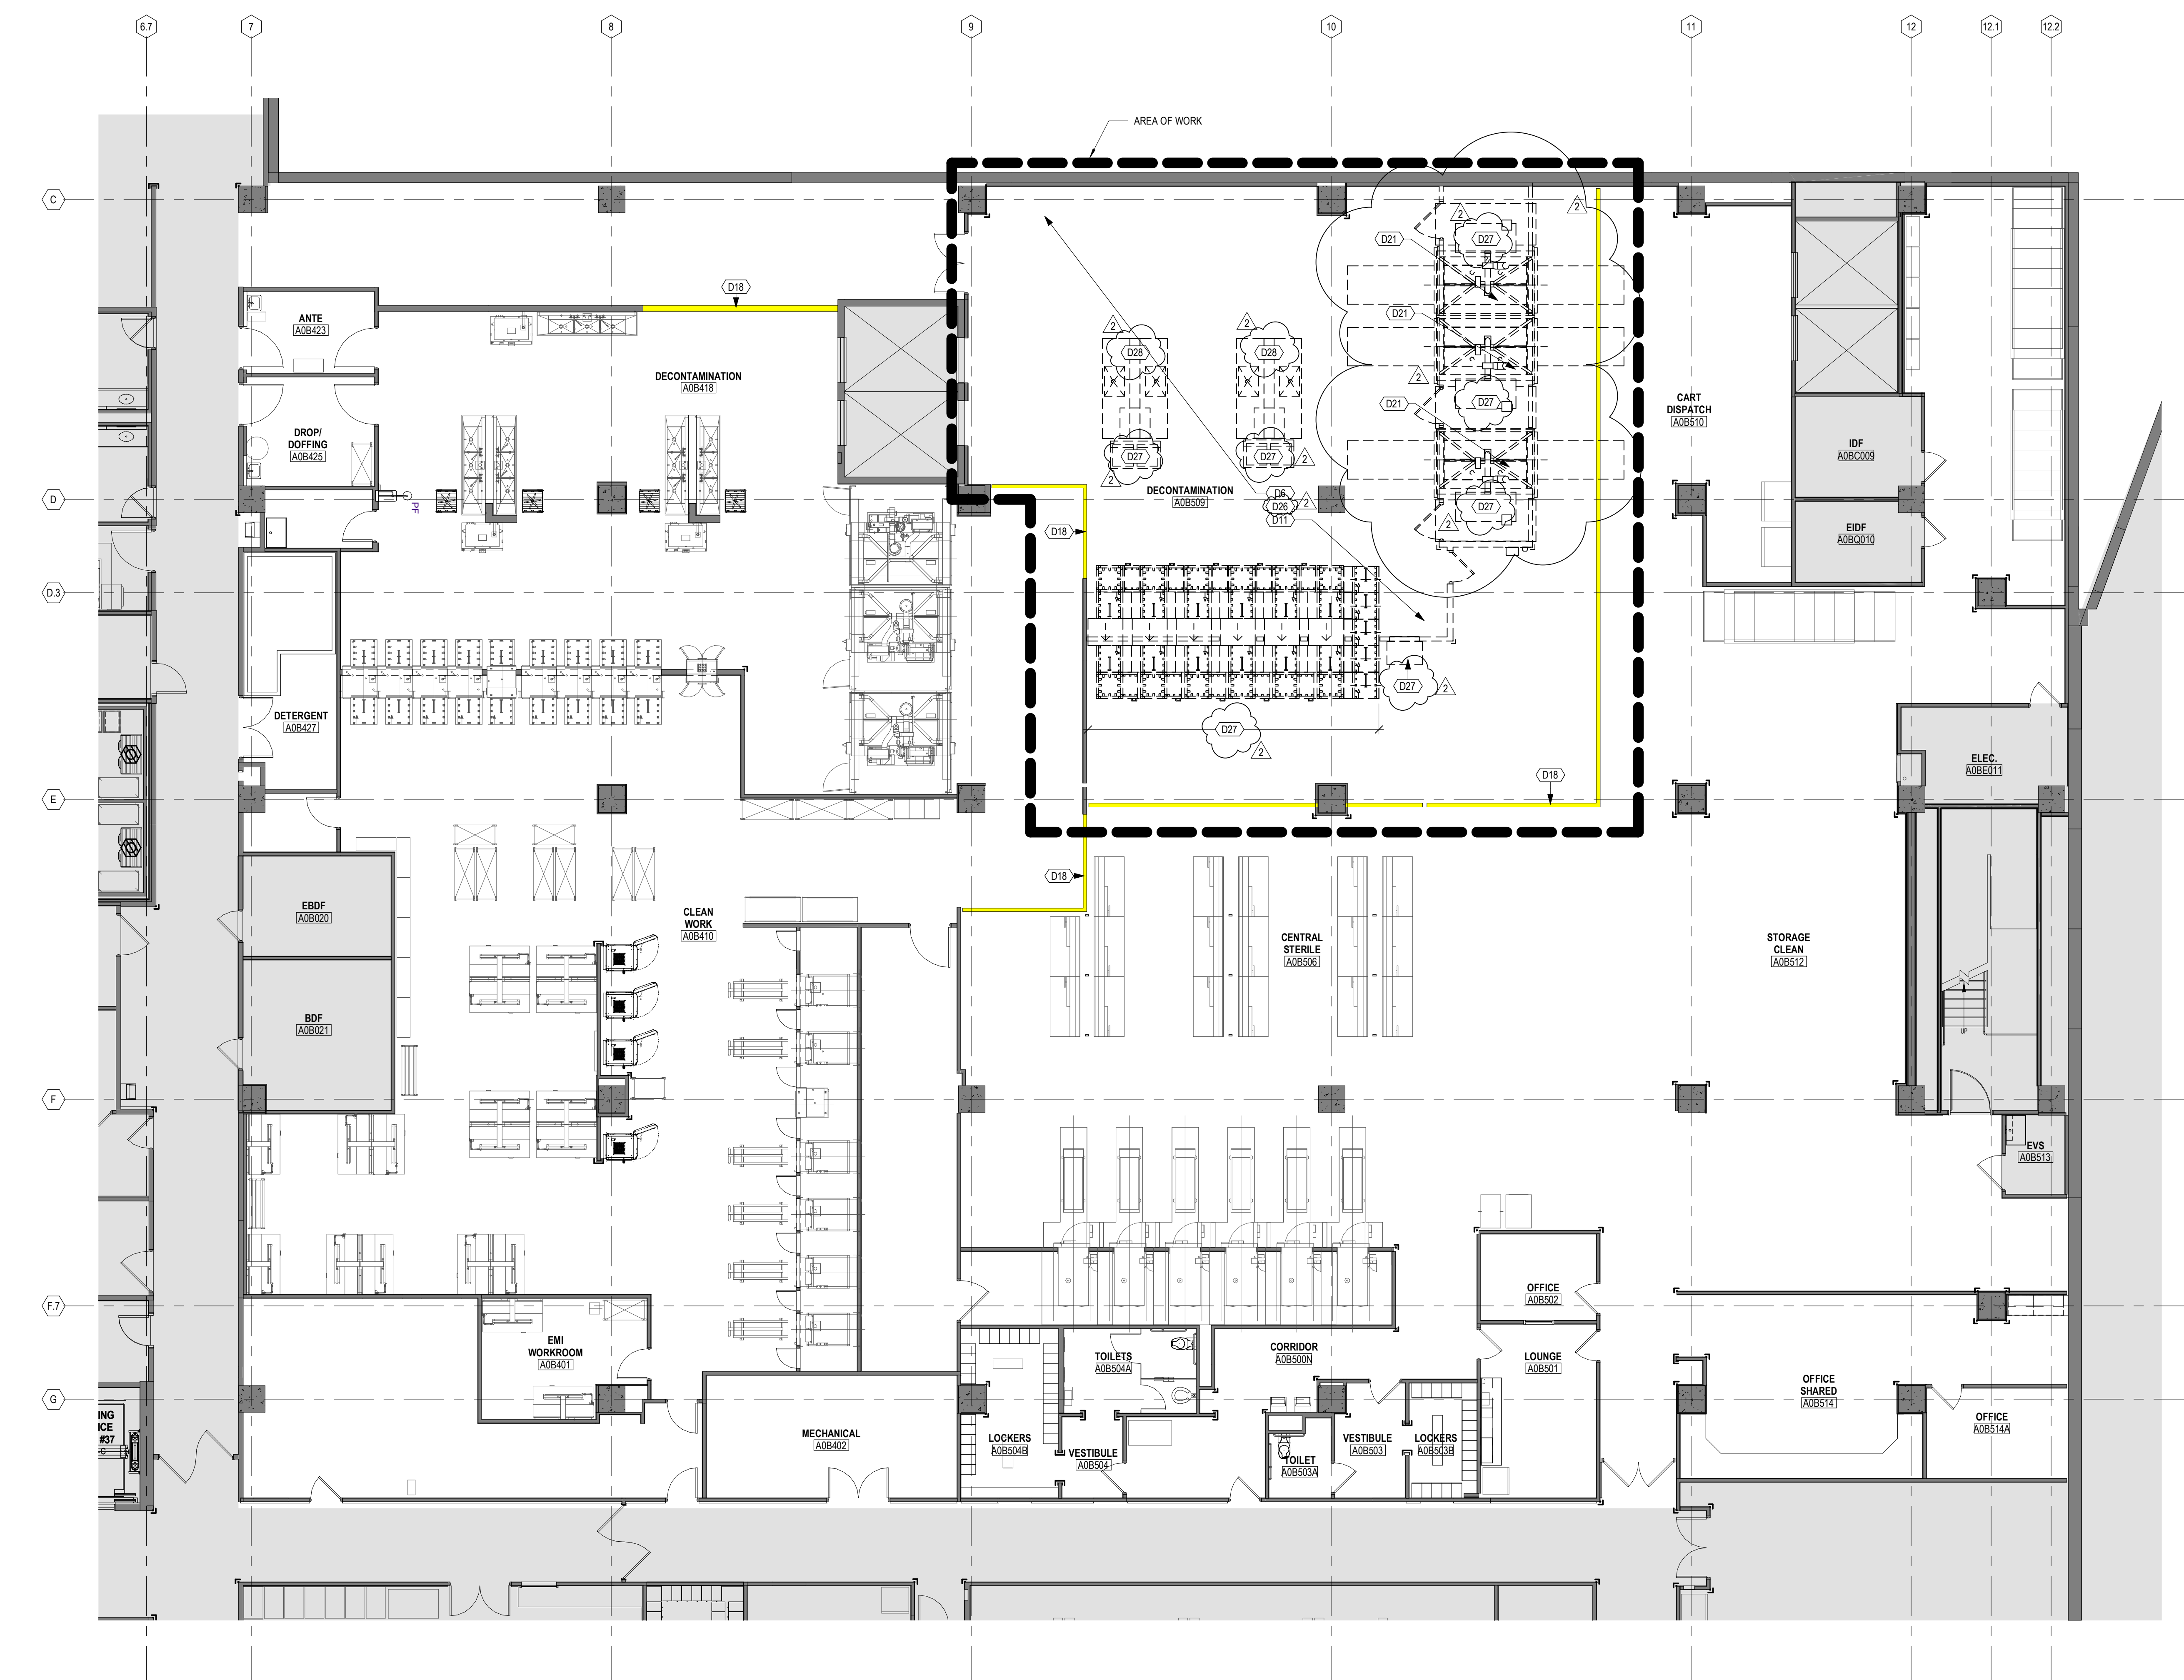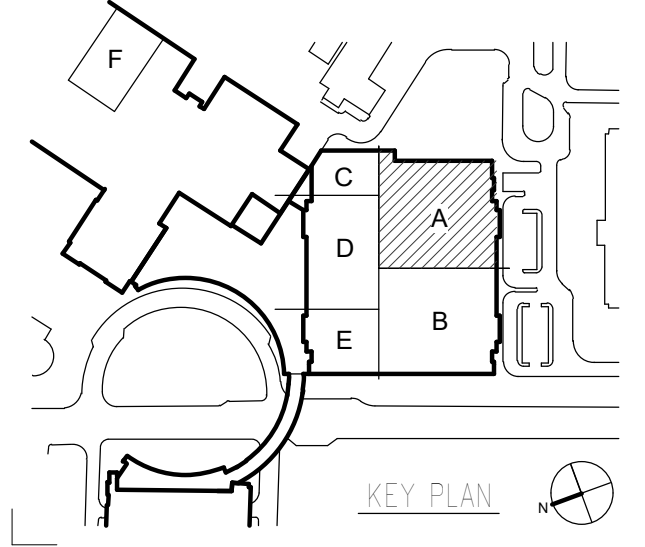

LEVEL B DEMOLITION PLAN AREA A PHASE 3
SCALE: 1/8" = 1'-0"

05/20/2022 11:06:16 AM BIM 360://UK - Pavilion A - Level B Support Services Renovation/UK-RED_APCD_PLA_LAB_Spl_Sch_Remo_D03.rvt

LEVEL B SUPPORT SERVICES RENOVATION | PAVILION A, 1000 S. LIMESTONE, LEXINGTON, KY 40536

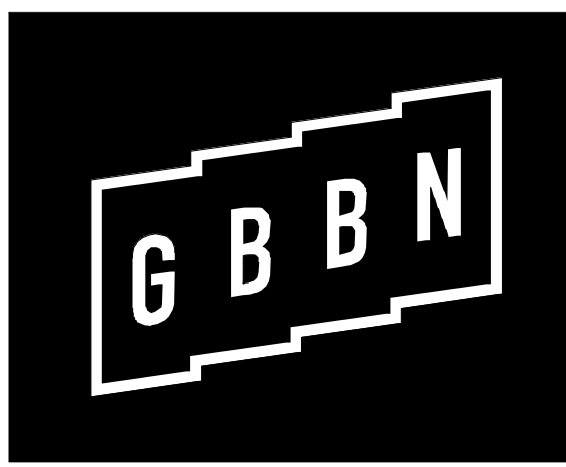

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DRAWING ISSUE

CONTRACT DOCUMENTS

NO.	DATE	DESCRIPTION
1	05.20.22	CD/BD DOCUMENTS BP#2
2	09.20.22	BP2 ADDENDUM 6

DRAWING TITLE

**LEVEL B DEMOLITION
PLAN - AREA A PHASE 5**

SEAL



JOB NUMBER

14590.01

D10B-A.5

05/20/2022

GENERAL NOTES: DEMOLITION FLOOR PLAN



- A. PHASING**
 - DRAWING DEPICTS COMPLETED DEMOLITION SCOPE. REFER TO PHASING PLANS FOR GENERAL DESCRIPTION OF PHASING.
 - B. DEMOLITION PROCEDURES**
 - REFER TO THE PROJECT MANUAL FOR GENERAL DEMOLITION PROCEDURES, SALVAGING, PROTECTION, COORDINATION WITH NEW WORK, TRAFFIC AND CIRCULATION, UTILITIES, ACCESS AND TEMPORARY CONTROLS, FACILITIES, POLLUTION CONTROLS, SHORING, CUTTING AND PATCHING, LIFE SAFETY PROCEDURES, AND OTHER DEMOLITION REQUIREMENTS DESCRIBED THEREIN.
 - C. COORDINATION**
 - COORDINATE DEMOLITION INFORMATION SHOWN ON THIS PLAN WITH OTHER DEMOLITION TRADES AND WITH NEW WORK INDICATED ON OTHER DRAWINGS.
 - D. ARCHITECTURAL DEMOLITION**
 - THE INTENT OF THIS PLAN IS TO DESCRIBE GENERAL AREAS OF DEMOLITION.
 - WHERE INTERIOR SPACES ARE SHOWN WITH DASHED LINES AND EXCEPT AS INDICATED OTHERWISE, REMOVE AND DISPOSE OF THE FOLLOWING: NON-LOAD BEARING PARTITIONS, WALL-MOUNTED ITEMS, DOORS AND FRAMES, FLOORING, FINISHED CEILINGS, CEILING SUSPENSION SYSTEMS, CEILING MOUNTED DEVICES, CASEWORK, MILLWORK, AND TRIM.
 - E. MECHANICAL, ELECTRICAL, PLUMBING, FIRE PROTECTION DEMOLITION**
 - REFER TO MECHANICAL, ELECTRICAL, PLUMBING AND FIRE PROTECTION DRAWINGS FOR ADDITIONAL DEMOLITION REQUIREMENTS. DISCONNECT AND CAP UTILITIES AS INDICATED THEREIN.
 - F. WALL MOUNTED ITEMS**
 - UNLESS INDICATED OTHERWISE, REMOVE AND DISPOSE OF WALL-MOUNTED AND COLUMN-MOUNTED ITEMS WHERE WALLS AND COLUMNS ARE TO REMAIN.
 - COORDINATE WITH MECHANICAL, ELECTRICAL, PLUMBING AND FIRE PROTECTION DRAWINGS.
 - G. HAZARDOUS MATERIALS**
 - IN THE EVENT A CONTRACTOR ENCOUNTERS, ON THE SITE, MATERIAL REASONABLY BELIEVED TO BE ASBESTOS OR POLYCHLORINATED BIPHENYL (PCB) WHICH HAS NOT BEEN RENDERED HARMLESS, THE CONTRACTOR SHALL IMMEDIATELY STOP WORK IN THE AREA AFFECTED AND REPORT THE CONDITION TO THE OWNER, ARCHITECT, AND CONSTRUCTION MANAGER IN WRITING. REFER ALSO TO THE GENERAL CONDITIONS OF THE CONTRACT.
 - H. FLOOR EXCAVATION FOR UNDERSLAB WORK**
 - EXCAVATION SCOPE SHOWN IS APPROXIMATE. REFER TO MECHANICAL, PLUMBING, AND ELECTRICAL DRAWINGS FOR EXACT LOCATIONS OF NEW WORK; REFER TO STRUCTURAL DRAWINGS FOR FILL DETAILS.
- EQUIPMENT**
DISASSEMBLY AND REMOVAL BY OTHERS. MEP TO DISCONNECT AND REMOVE PIPING, DUCTWORK, CONDUIT, ETC. PER PLANS.

DEMOLITION GRAPHIC KEY

- REMOVE WALL / PARTITION FULL HEIGHT TO STRUCTURE
- REMOVE DOOR. REFER TO DOOR SCHEDULE FOR INSTANCES OF REUSING THE FRAME AND/OR SALVAGING HARDWARE.
- REMOVE WINDOW - SASH AND FRAME
- SLAB TO BE REMOVED AND REPLACED TO FACILITATE CONSTRUCTION OF UTILITIES. AREAS ARE DIAGRAMMATIC. REFER TO MEP DRAWINGS FOR EXACT SIZE AND LOCATION. REFER TO STRUCTURAL DRAWINGS FOR DETAIL.
- WALL / PARTITION TO REMAIN
- DOOR TO REMAIN
- AREA NOT IN SCOPE

HEX (D) DEMOLITION PLAN NOTES

- KEYNOTE** **DESCRIPTION**
- D1 REMOVE EXISTING WALL FOR NEW OPENING
 - D2 REMOVE EXISTING TOILET PARTITION
 - D6 REMOVE AND REPLACE EXISTING CEILING AND LIGHTING; GRID AND SPRINKLER HEADS TO REMAIN AND BE REUSED. REFER TO MEP DRAWINGS.
 - D7 REMOVE EXISTING PLUMBING FIXTURES AND ACCESSORIES; COORDINATE WITH MEP DRAWINGS AND SPECIFICATIONS.
 - D9 REMOVE EXISTING CASEWORK
 - D11 REMOVE EXISTING FLOORING AND ASSOCIATED ADHESIVES
 - D13 REMOVE EXISTING LOCKERS AND BENCHES. CONTRACTOR TO REMOVE AND TRANSPORT TO PAV A AND FLOOR.
 - D14 EQUIPMENT/FURNITURE TO BE REMOVED BY OTHERS
 - D18 TEMPORARY WALL SHOWN FOR REFERENCE. CM TO CONTROL TEMPORARY BARRIER LOCATIONS; WORK BY GENERAL TRADES.
 - D30 SALVAGE REFRIGERATOR. STORE IN PAV A SECOND FLOOR SHELTER SPACE. CONTRACTOR TO MAKE SAFE FOR REMOVAL AND DISCONNECT AND RELOCATE IN PAV A BASEMENT. REFER TO MEP PLANS FOR SYSTEMS DISCONNECT.
 - D31

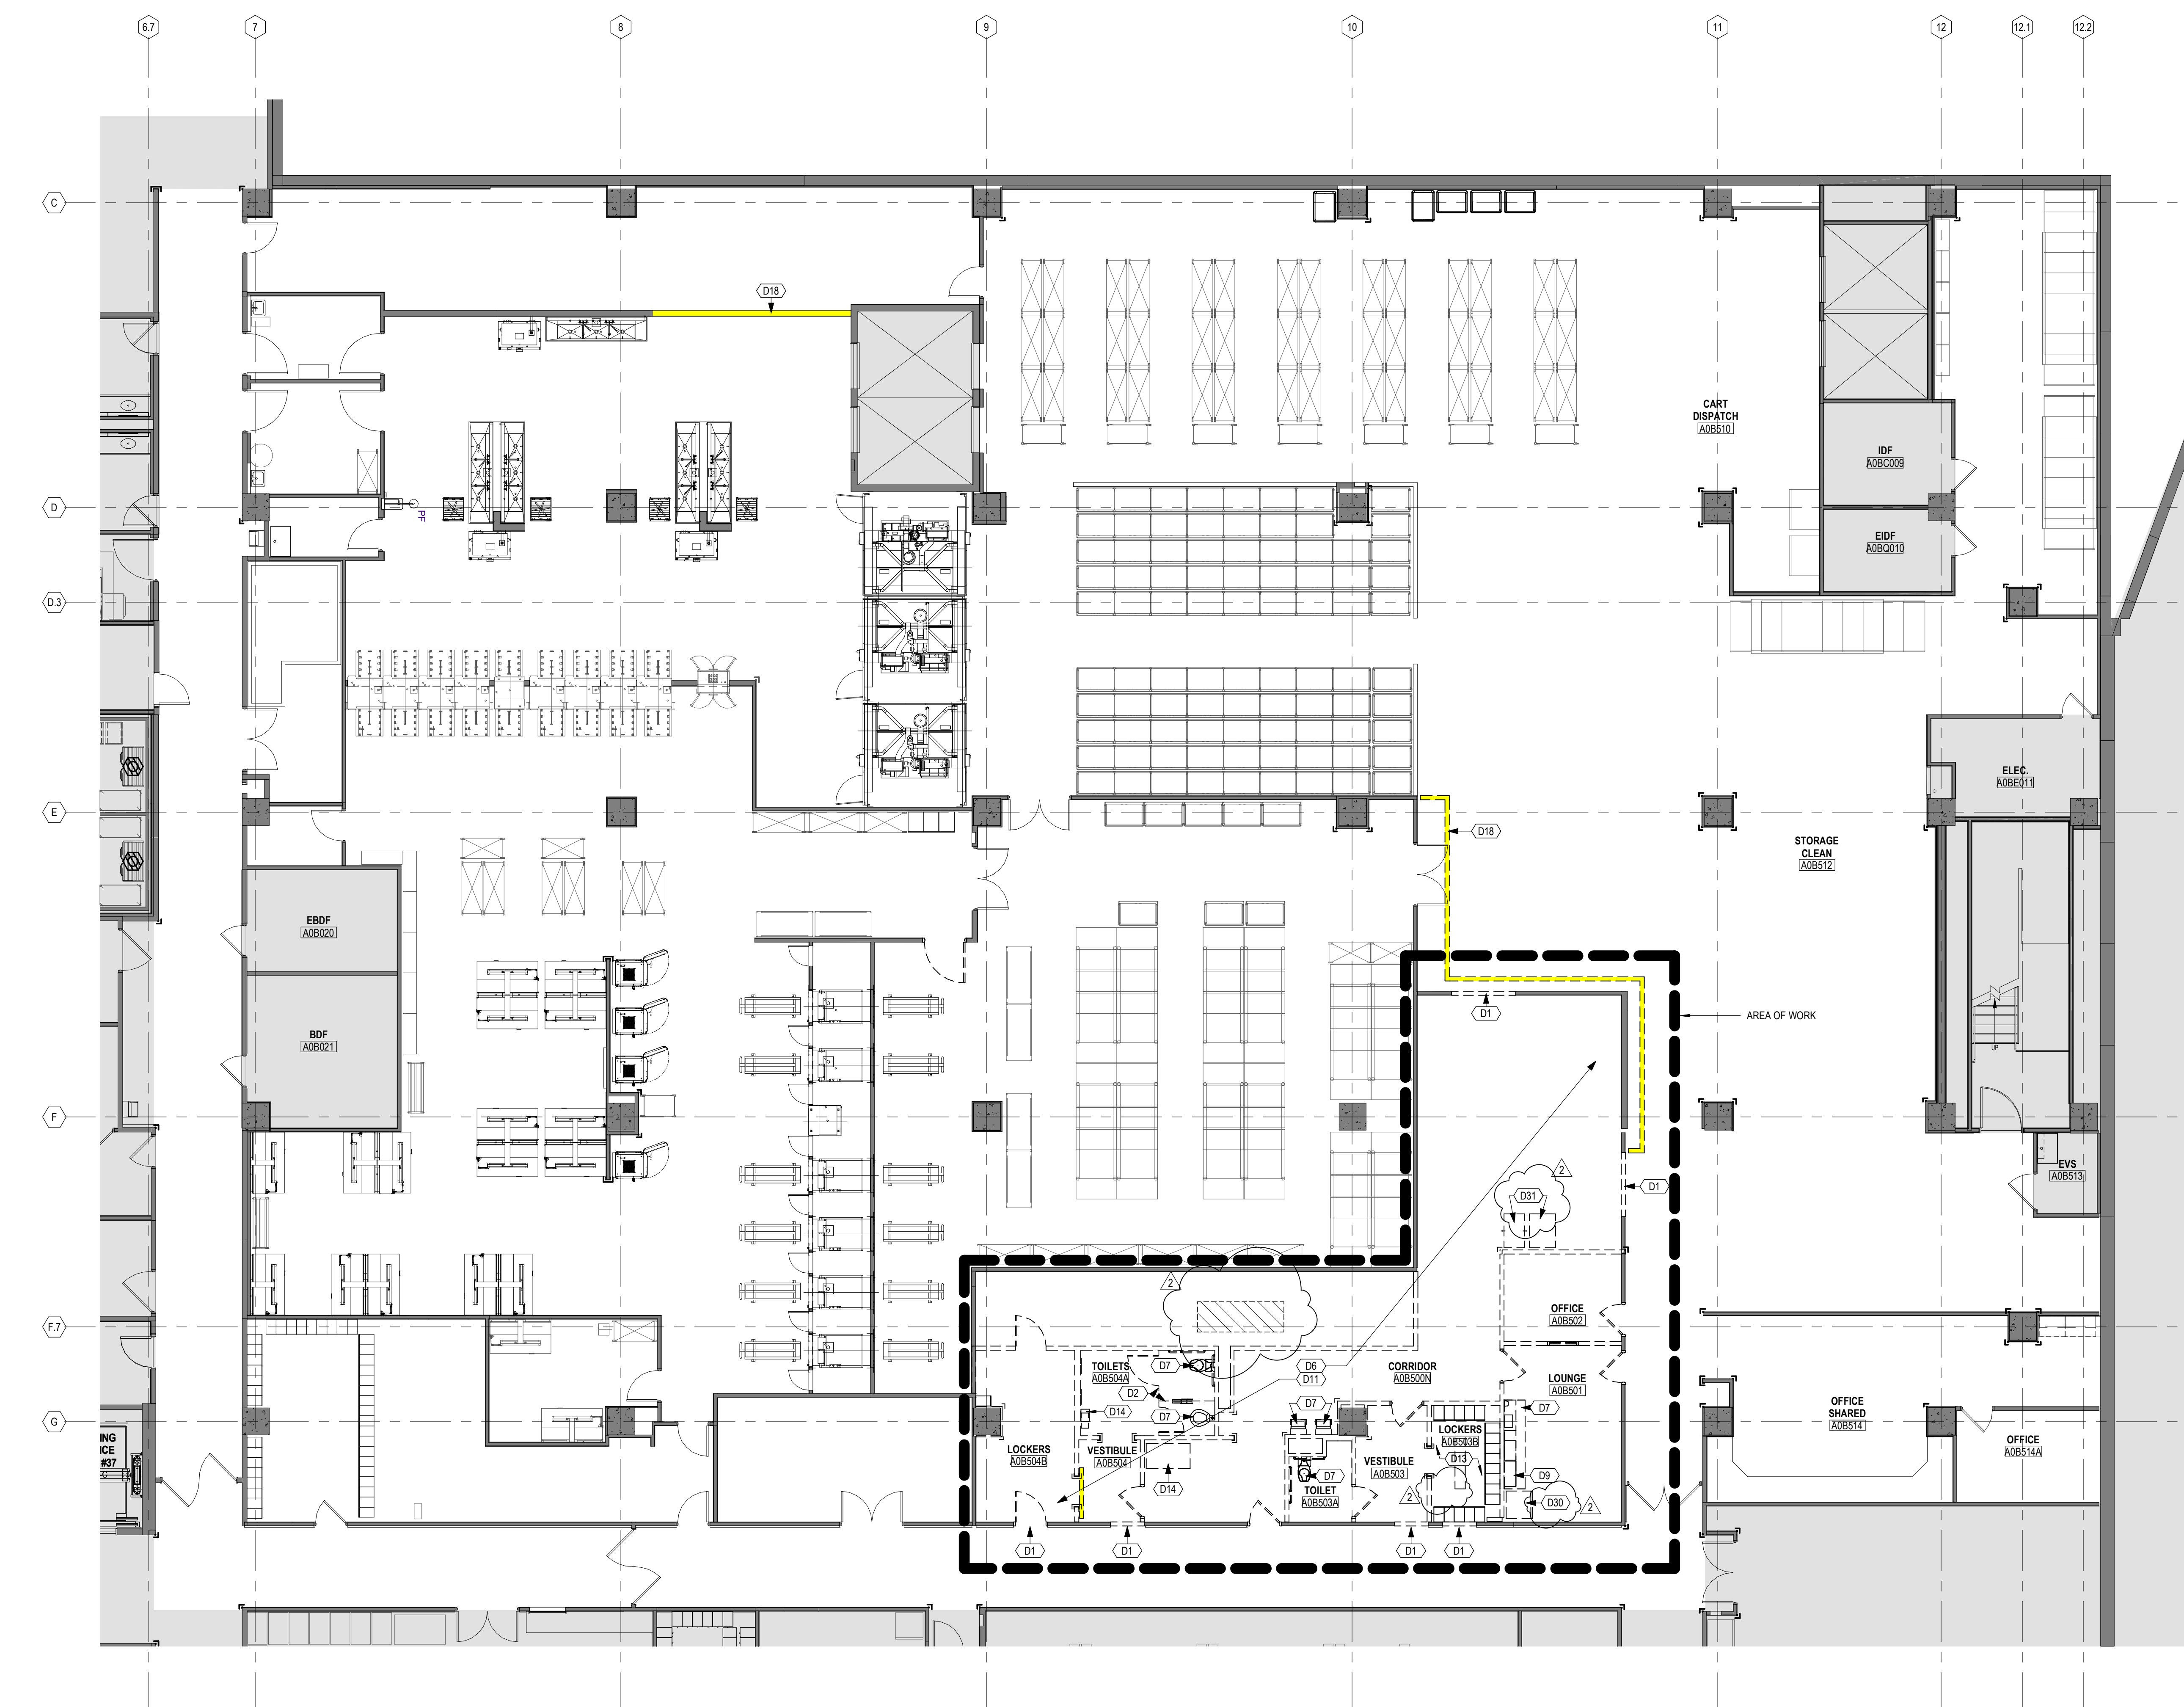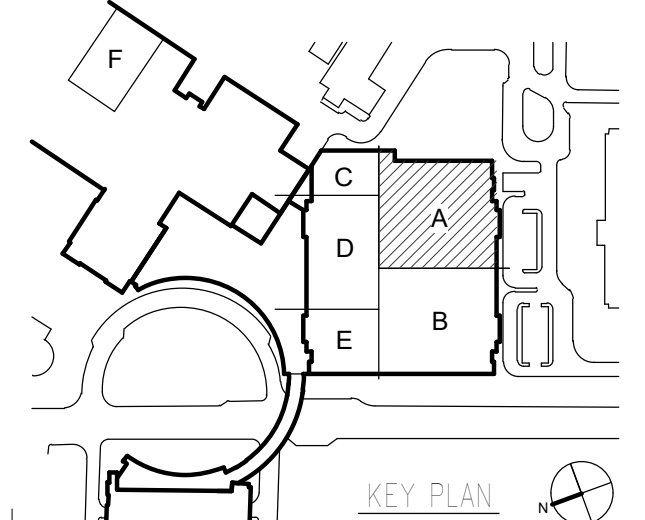

LEVEL B DEMOLITION PLAN AREA A PHASE 5
SCALE: 1/8" = 1'-0"

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LEVEL B SUPPORT SERVICES RENOVATION | PAVILION A, 1000 S. LIMESTONE, LEXINGTON, KY 40536

01/20/2022 10:38 PM BIM 360://UK - Pavilion A - Level B Support Services Renovation/UK-RED_ARCH_PA_LB_SJ_Soc_Remo_D01A



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UK HealthCare
Renovate / Upgrade
UK Healthcare
Facilities
Pavilion A Level B
Project Number: 2239.77

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HealthCare
800 Rose Street
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DRAWING ISSUE

CONTRACT DOCUMENTS

NO.	DATE	DESCRIPTION
1	05/20/22	CD/BDI DOCUMENTS BP#2
2	09/20/22	BP2 ADDENDUM 6

DRAWING TITLE

LEVEL B DEMOLITION PLAN - AREA A PHASE 6

SEAL



JOB NUMBER

14590.01

D10B-A.6

05/20/2022

GENERAL NOTES: DEMOLITION FLOOR PLAN


- A. PHASING**
 - DRAWING DEPICTS COMPLETED DEMOLITION SCOPE. REFER TO PHASING PLANS FOR GENERAL DESCRIPTION OF PHASING.
- B. DEMOLITION PROCEDURES**
 - REFER TO THE PROJECT MANUAL FOR GENERAL DEMOLITION PROCEDURES, SALVAGING, PROTECTION, COORDINATION WITH NEW WORK, TRAFFIC AND CIRCULATION, UTILITIES, ACCESS AND TEMPORARY CONTROLS, FACILITIES, POLLUTION CONTROLS, SHORING, CUTTING AND PATCHING, LIFE SAFETY PROCEDURES, AND OTHER DEMOLITION REQUIREMENTS DESCRIBED THEREIN.
- C. COORDINATION**
 - COORDINATE DEMOLITION INFORMATION SHOWN ON THIS PLAN WITH OTHER DEMOLITION TRADES AND WITH NEW WORK INDICATED ON OTHER DRAWINGS.
- D. ARCHITECTURAL DEMOLITION**
 - THE INTENT OF THIS PLAN IS TO DESCRIBE GENERAL AREAS OF DEMOLITION.
 - WHERE INTERIOR SPACES ARE SHOWN WITH DASHED LINES AND EXCEPT AS INDICATED OTHERWISE, REMOVE AND DISPOSE OF THE FOLLOWING: NON-LOAD BEARING PARTITIONS, WALL-MOUNTED ITEMS, DOORS AND FRAMES, FLOORING, FINISHED CEILINGS, CEILING SUSPENSION SYSTEMS, CEILING MOUNTED DEVICES, CASEWORK, MILLWORK, AND TRIM.
- E. MECHANICAL, ELECTRICAL, PLUMBING, FIRE PROTECTION DEMOLITION**
 - REFER TO MECHANICAL, ELECTRICAL, PLUMBING AND FIRE PROTECTION DRAWINGS FOR ADDITIONAL DEMOLITION REQUIREMENTS. DISCONNECT AND CAP UTILITIES AS INDICATED THEREIN.
- F. WALL MOUNTED ITEMS**
 - UNLESS INDICATED OTHERWISE, REMOVE AND DISPOSE OF WALL-MOUNTED AND COLUMN-MOUNTED ITEMS WHERE WALLS AND COLUMNS ARE TO REMAIN.
 - COORDINATE WITH MECHANICAL, ELECTRICAL, PLUMBING AND FIRE PROTECTION DRAWINGS.
- G. HAZARDOUS MATERIALS**
 - IN THE EVENT A CONTRACTOR ENCOUNTERS, ON THE SITE, MATERIAL REASONABLY BELIEVED TO BE ASBESTOS OR POLYCHLORINATED BI-PHENYL (PCB) WHICH HAS NOT BEEN RENDERED HARMLESS, THE CONTRACTOR SHALL IMMEDIATELY STOP WORK IN THE AREA AFFECTED AND REPORT THE CONDITION TO THE OWNER, ARCHITECT, AND CONSTRUCTION MANAGER IN WRITING. REFER ALSO TO THE GENERAL CONDITIONS OF THE CONTRACT.
- H. FLOOR EXCAVATION FOR UNDERSLAB WORK**
 - EXCAVATION SCOPE SHOWN IS APPROXIMATE. REFER TO MECHANICAL, PLUMBING, AND ELECTRICAL DRAWINGS FOR EXACT LOCATIONS OF NEW WORK; REFER TO STRUCTURAL DRAWINGS FOR FILL DETAILS.

DEMOLITION GRAPHIC KEY


- REMOVE WALL / PARTITION FULL HEIGHT TO STRUCTURE
- - - REMOVE DOOR. REFER TO DOOR SCHEDULE FOR INSTANCES OF REUSING THE FRAME AND/OR SALVAGING HARDWARE.
- - - REMOVE WINDOW - SASH AND FRAME
- ▨ SLAB TO BE REMOVED AND REPLACED TO FACILITATE CONSTRUCTION OF UTILITIES. AREAS ARE DIAGRAMMATIC. REFER TO MEP DRAWINGS FOR EXACT SIZE AND LOCATION. REFER TO STRUCTURAL DRAWINGS FOR DETAIL.
- ▬ WALL / PARTITION TO REMAIN
- ◁ DOOR TO REMAIN
- AREA NOT IN SCOPE

HEX (D) DEMOLITION PLAN NOTES

KEYNOTE	DESCRIPTION
D1	REMOVE EXISTING WALL FOR NEW OPENING
D4	UNBOLT EXISTING HIGH DENSITY SHELVING. SALVAGE TO PAV A SHIPPING DOCK
D9	REMOVE EXISTING CASEWORK
D13	REMOVE EXISTING LOCKERS AND BENCHES - CONTRACTOR TO REMOVE AND TRANSPORT TO PAV A 2ND FLOOR
D18	TEMPORARY WALL SHOWN FOR REFERENCE. CM TO CONTROL TEMPORARY BARRIER LOCATIONS. WORK BY GENERAL TRADES.
D26	EXISTING DOWNPIPE TO BE DEMOLISHED BY CONTRACTOR
D32	CONTRACTOR TO DISCONNECT FREEZERS AND TRANSPORT THEM TO PAV A LOADING DOCK. SEE E0508A NUMBER FR20889 FOR FUTURE RELOCATION LOCATION.

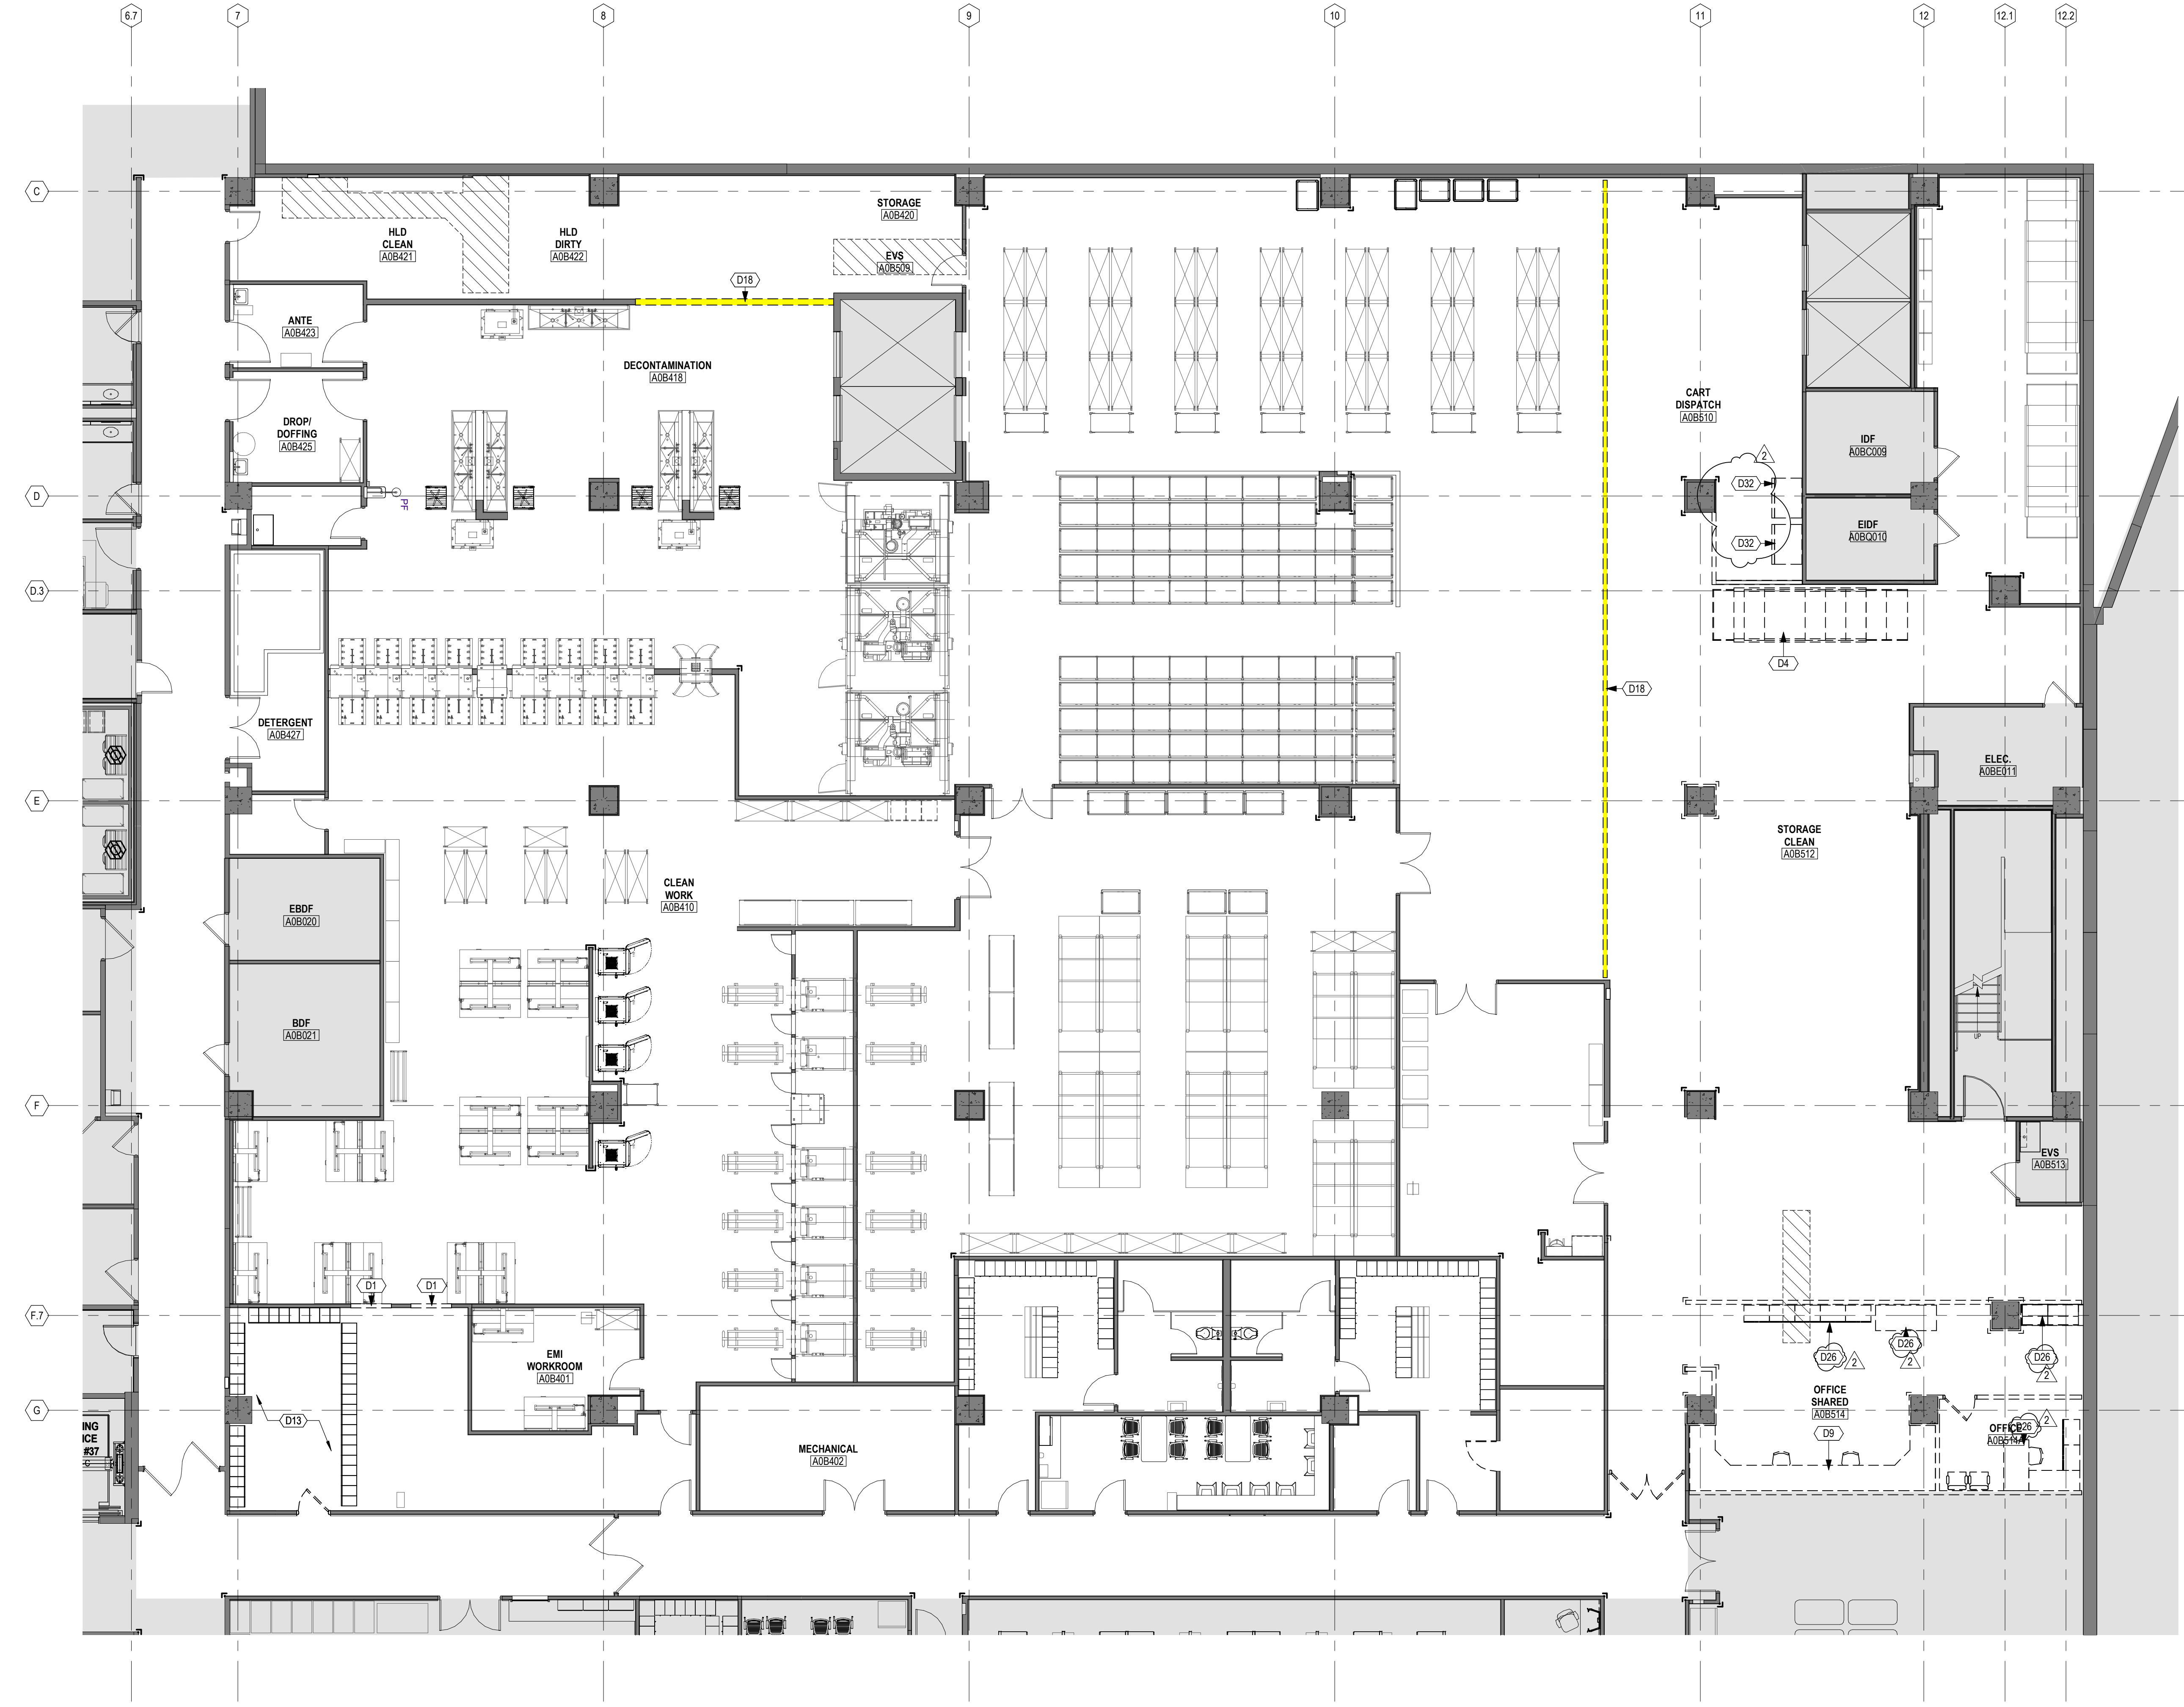

LEVEL B DEMOLITION PLAN AREA A PHASE 6
D10B-A.6 SCALE: 1/8" = 1'-0"

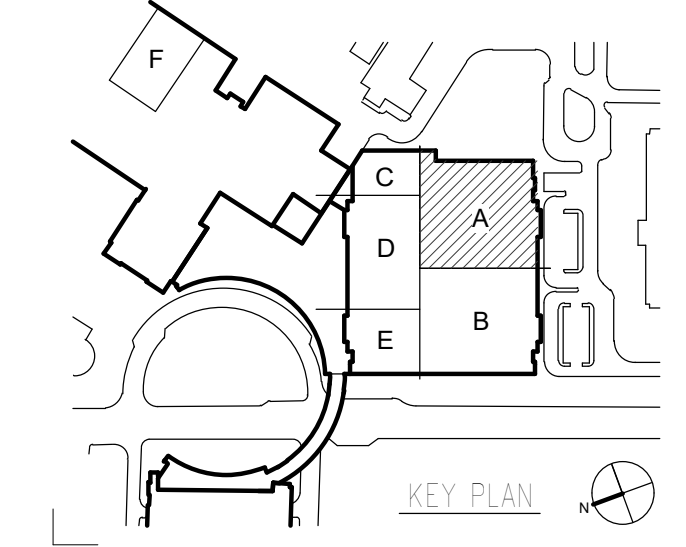

LEVEL B SUPPORT SERVICES RENOVATION | PAVILION A, 1000 S. LIMESTONE, LEXINGTON, KY 40536



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Renovate / Upgrade
 UK HealthCare
 Facilities
 Pavilion A Level B
 Project Number: 2239.77

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DRAWING ISSUE

CONTRACT DOCUMENTS

NO.	DATE	DESCRIPTION
1	05/20/22	CD/BID DOCUMENTS BP#2
2	09/20/22	BP2 ADDENDUM 6

DRAWING TITLE

LEVEL B DIMENSION PLAN - AREA A PHASE 2

SEAL



JOB NUMBER

14590.01

A10B-A.2

05/20/2022

GENERAL NOTES - FLOOR PLAN

- A. **LAYOUT AND DIMENSIONS**
DO NOT SCALE THE DRAWINGS. LAYOUT THE PARTITIONS AND OPENINGS PRIOR TO CONSTRUCTION. NOTIFY THE ARCHITECT OF ANY DISCREPANCIES WITH THE DRAWINGS.
- B. **PARTITION ALIGNMENT**
UNLESS NOTED OTHERWISE, ALIGN NEW PARTITIONS WITH THE FACE OF EXISTING CONSTRUCTION AS APPLICABLE. WHERE NEW CONSTRUCTION IS SHOWN TO FILL EXISTING WALL OPENINGS, BOTH FACES OF THE NEW CONSTRUCTION SHALL ALIGN WITH THE EXISTING WALL FACES UNLESS INDICATED OTHERWISE.
- C. **DOOR LOCATIONS**
EXCEPT WHERE DIMENSIONED OTHERWISE, LOCATE OUTER EDGES OF DOOR FRAMES 4-INCHES FROM PERPENDICULAR WALLS AND PARTITIONS.
- D. **DIMENSIONING**
DIMENSIONS LOCATING FRAMED PARTITIONS OR FURRED-OUT CONCRETE OR MASONRY PARTITIONS ARE TAKEN FROM THE FACE OF WALLBOARD (OR PLASTER WHERE APPLICABLE). DIMENSIONS LOCATING EXPOSED CONCRETE OR MASONRY WALLS ARE TAKEN FROM THE FACE OF CONCRETE OR MASONRY. UNLESS INDICATED OTHERWISE, THICKNESSES OF APPLIED FINISHES ARE NOT INCLUDED IN THE PLAN DIMENSION. REFER TO THE FINISH SCHEDULE AND DETAILS.
- E. **NEW SERVICES IN EXISTING WALLS**
PROVIDE NEW HARD-PIPED CONDUIT AND GYPSUM BOARD AT NEW DATA AND POWER LOCATIONS IN EXISTING WALLS.

PARTITION AND WALL GRAPHIC KEY

- NON-RATED PARTITION
- NON-RATED PARTITION (EXISTING)
- 1 HOUR FIRE BARRIER
- 1 HOUR FIRE BARRIER (EXISTING)
- 2 HOUR FIRE BARRIER
- 2 HOUR FIRE BARRIER (EXISTING)
- 1 HOUR FIRE AND SMOKE BARRIER
- 1 HOUR FIRE AND SMOKE BARRIER (EXISTING)
- 2 HOUR FIRE AND SMOKE BARRIER
- 2 HOUR FIRE AND SMOKE BARRIER (EXISTING)
- SMOKE RESISTING PARTITION
- SMOKE RESISTING PARTITION (EXISTING)
- 1 HOUR SMOKE BARRIER
- 1 HOUR SMOKE BARRIER (EXISTING)

PARTITION TAG GRAPHIC KEY

- FIRE ASSEMBLY RATING (HOURS) OR SMOKE PARTITION REQUIREMENT
- PARTITION TYPE - REFER TO SHEET A601
- PARTITION WALL MODIFICATION


AREA NOT IN SCOPE

KEYNOTE


- A5 TEMPORARY WALL SHOWN FOR REFERENCE. CM TO CONTROL TEMPORARY BARRIER LOCATIONS. WORK BY GENERAL TRADES.

SECURITY HARDWARE

- WALL MOUNTED CARD READER
- INTERCOM SUB STATION WITH VIDEO CAMERA TO COMMUNICATE TO DEPARTMENT ENTRIES
- AUTOMATIC OPERATOR
- KEYPAD LOCK
- DOOR RELEASE BUTTON CONNECTION
- INTERCOM SUB STATION / PHONE TO COMMUNICATE WITHIN DEPARTMENT (TO SPEAKERS)
- CLOSER

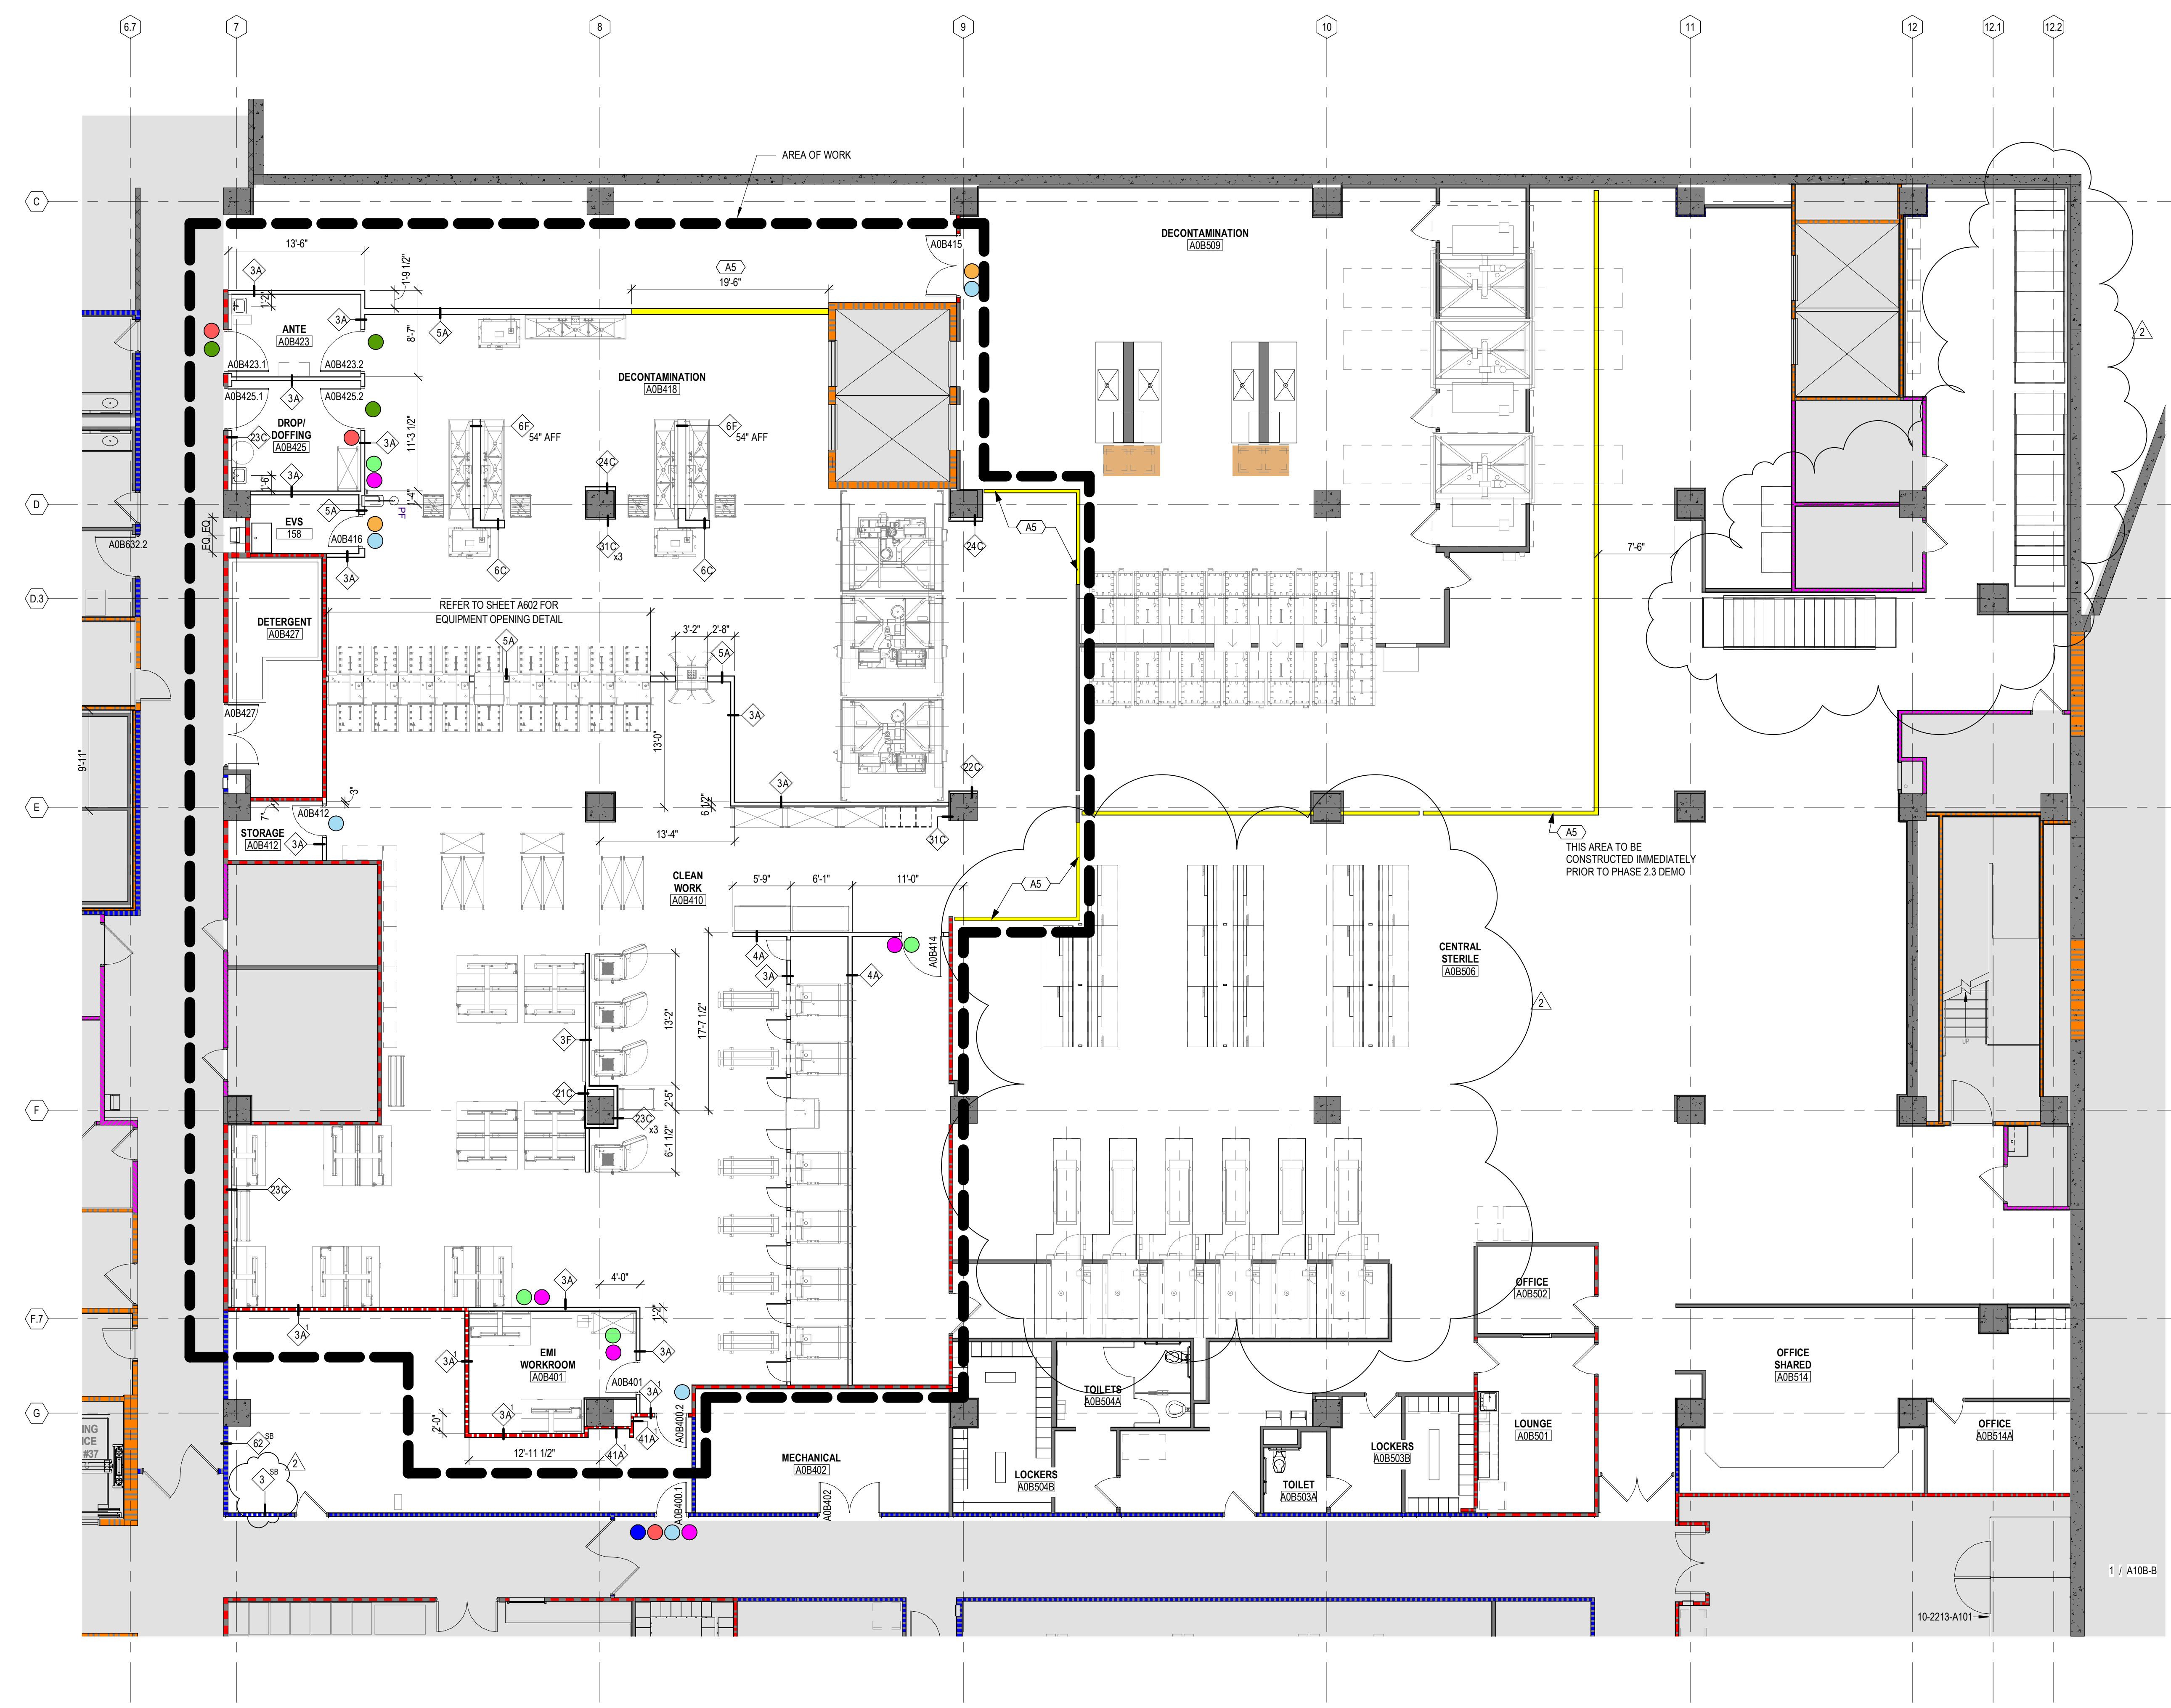

LEVEL B DIMENSION PLAN AREA A.2
 SCALE: 1/8" = 1'-0"

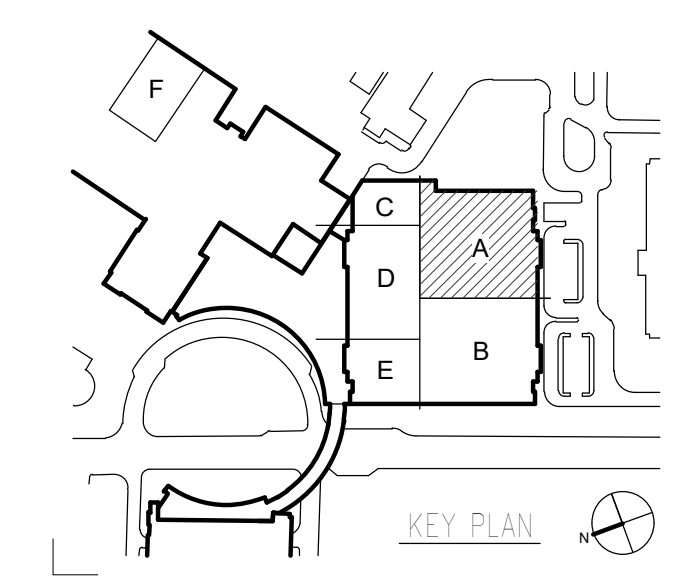

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LEVEL B SUPPORT SERVICES RENOVATION | PAVILION A, 1000 S. LIMESTONE, LEXINGTON, KY 40536

HEX (A) FLOOR PLAN NOTES

KEYNOTE	DESCRIPTION
A5	TEMPORARY WALL SHOWN FOR REFERENCE. CM TO CONTROL TEMPORARY BARRIER LOCATIONS. WORK BY GENERAL TRADES.
A6	TEMPORARY LOCKERS
A13	EXISTING 8" SLAB RECESS. FIELD VERIFY TOP OF EXISTING SLAB RECESS PERIMETER STEEL ANGLE IS FLUSH WITH SURROUNDING SLAB AREA. IF EDGE ANGLE IS NOT FLUSH NOTIFY ARCHITECT FOR DIRECTION. PERMANENTLY CAP DRAINS WITHIN SLAB RECESS. INFILL RECESSED AREA TO HAVE FLUSH FINISHED SURFACE WITH TYPICAL SURROUNDING SLAB AREA. INFILL SHALL BE 4000 PSI CONCRETE SLAB REINFORCED WITH #3@8" ON CENTER EACH WAY. REINFORCEMENT SHALL BE CHAIRED IN PLACE AT 1" CLEAR FROM TOP OF SLAB. PRIOR TO PLACING SLAB, CLEAN EXISTING SURFACES TO BE BONDED WITH FRESH CONCRETE AND COAT WITH A BONDING AGENT (ASTM C 1099 TYPE II). TOOL JOINT AROUND SLAB PERIMETER, AT INTERFACE WITH EXISTING PIT EDGE ANGLE TO CREATE A 1/2" WIDE X 1/2" DEEP JOINT AROUND THE NEW INFILL SLAB. FILL JOINT WITH A SEMI-RIGID JOINT FILLER AFTER CONCRETE HAS FULLY CURED (TWO-COMPONENT WITH A TYPE A SHORE DUROMETER HARDNESS OF 90 MINIMUM ACCORDING TO ASTM D 2240). TRIM JOINT FILLER TO CREATE FLUSH TOP SURFACE TRANSITION.

- #### GENERAL NOTES - FLOOR PLAN
- LAYOUT AND DIMENSIONS**
DO NOT SCALE THE DRAWINGS. LAYOUT THE PARTITIONS AND OPENINGS PRIOR TO CONSTRUCTION. NOTIFY THE ARCHITECT OF ANY DISCREPANCIES WITH THE DRAWINGS.
 - PARTITION ALIGNMENT**
UNLESS NOTED OTHERWISE, ALIGN NEW PARTITIONS WITH THE FACE OF EXISTING CONSTRUCTION AS APPLICABLE. WHERE NEW CONSTRUCTION IS SHOWN TO FILL EXISTING WALL OPENINGS, BOTH FACES OF THE NEW CONSTRUCTION SHALL ALIGN WITH THE EXISTING WALL FACES UNLESS INDICATED OTHERWISE.
 - DOOR LOCATIONS**
EXCEPT WHERE DIMENSIONED OTHERWISE, LOCATE OUTER EDGES OF DOOR FRAMES 4-INCHES FROM PERPENDICULAR WALLS AND PARTITIONS.
 - DIMENSIONING**
DIMENSIONS LOCATING FRAMED PARTITIONS OR FURRED-OUT CONCRETE OR MASONRY PARTITIONS ARE TAKEN FROM THE FACE OF WALLBOARD (OR PLASTER WHERE APPLICABLE). DIMENSIONS LOCATING EXPOSED CONCRETE OR MASONRY WALLS ARE TAKEN FROM THE FACE OF CONCRETE OR MASONRY. UNLESS INDICATED OTHERWISE, THICKNESSES OF APPLIED FINISHES ARE NOT INCLUDED IN THE PLAN DIMENSION. REFER TO THE FINISH SCHEDULE AND DETAILS.
 - NEW SERVICES IN EXISTING WALLS**
PROVIDE NEW HARD-PIPPED CONDUIT AND GYPSUM BOARD AT NEW DATA AND POWER LOCATIONS IN EXISTING WALLS.



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Project Number: 2239.77

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Minnetonka, MN 55343
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DRAWING ISSUE

CONTRACT DOCUMENTS

NO.	DATE	DESCRIPTION
1	05.20.22	CD/BID DOCUMENTS BP#2
2	09.20.22	BP2 ADDENDUM 6

DRAWING TITLE

LEVEL B DIMENSION PLAN - AREA A PHASE 3

SEAL




JOB NUMBER

14590.01

A10B-A.3

05/20/2022

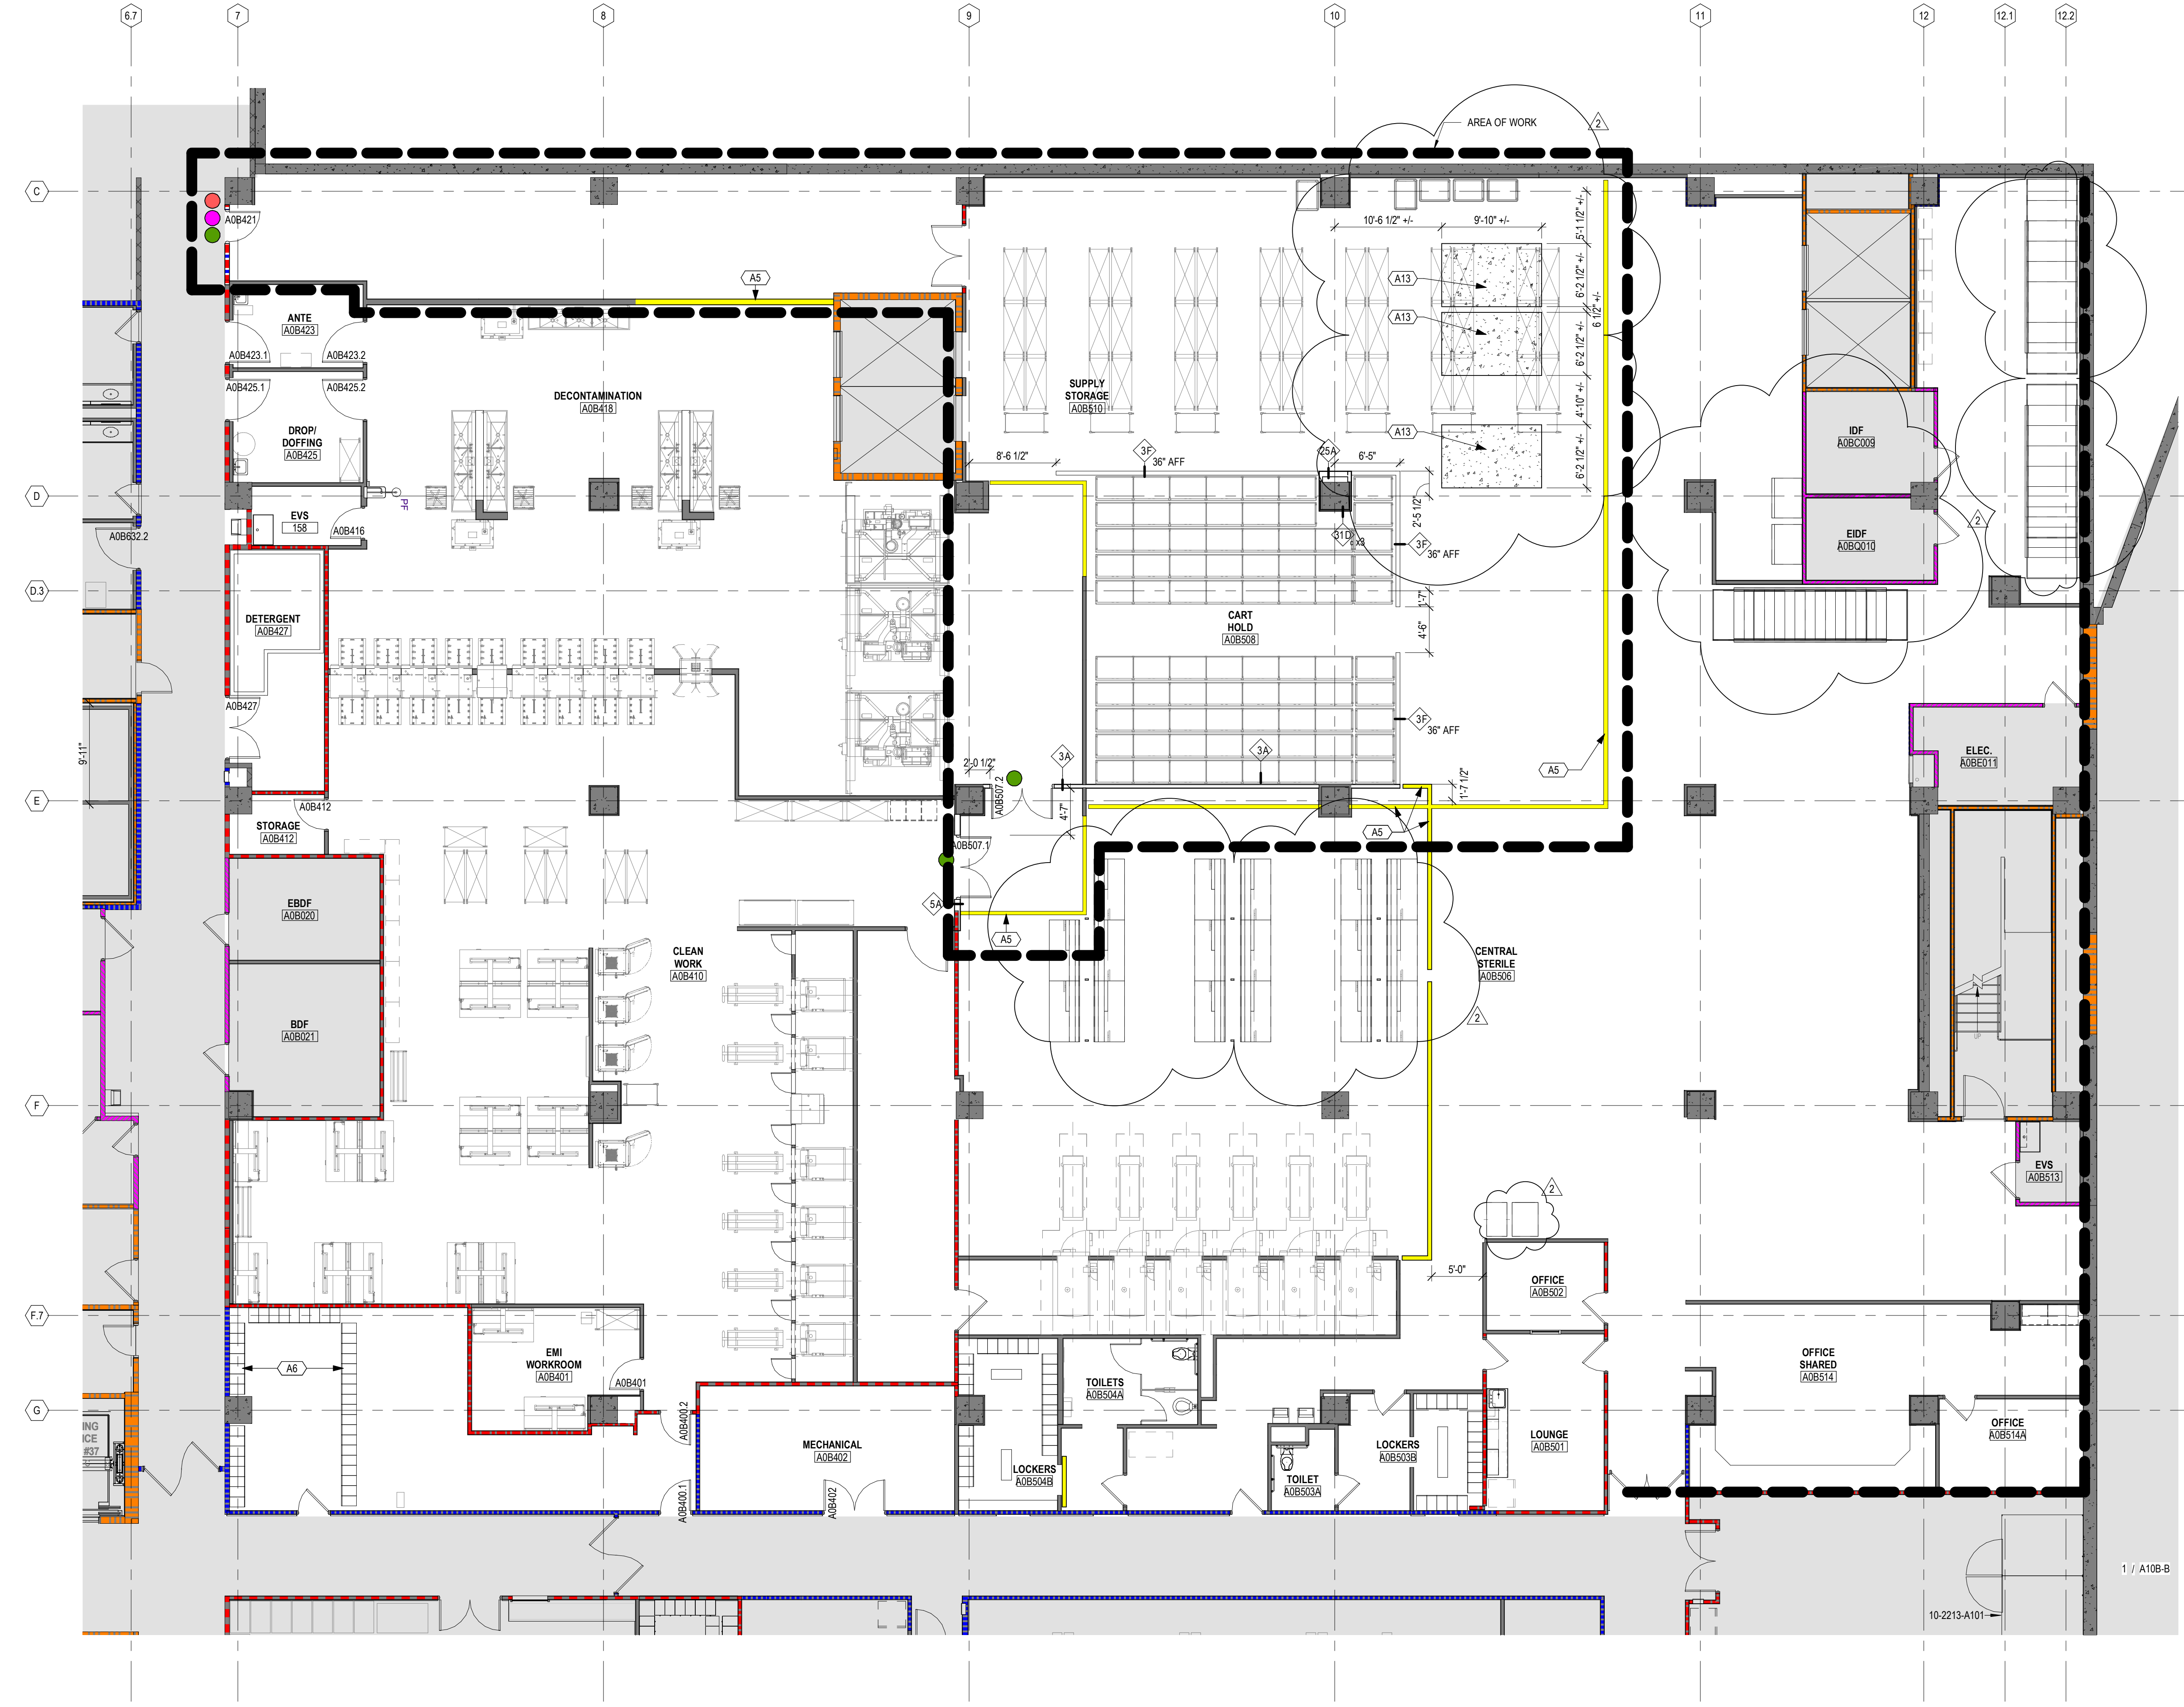

PARTITION AND WALL GRAPHIC KEY

- NON-RATED PARTITION
- NON-RATED PARTITION (EXISTING)
- 1 HOUR FIRE BARRIER
- 1 HOUR FIRE BARRIER (EXISTING)
- 2 HOUR FIRE BARRIER
- 2 HOUR FIRE BARRIER (EXISTING)
- 1 HOUR FIRE AND SMOKE BARRIER
- 1 HOUR FIRE AND SMOKE BARRIER (EXISTING)
- 2 HOUR FIRE AND SMOKE BARRIER
- SMOKE RESISTING PARTITION
- SMOKE RESISTING PARTITION (EXISTING)
- 1 HOUR SMOKE BARRIER
- 1 HOUR SMOKE BARRIER (EXISTING)

PARTITION TAG GRAPHIC KEY

- FIRE ASSEMBLY RATING (HOURS) OR SMOKE PARTITION REQUIREMENT
- PARTITION TYPE - REFER TO SHEET A601
- PARTITION WALL MODIFICATION
- AREA NOT IN SCOPE



KEYNOTE DESCRIPTION

- A5 TEMPORARY WALL SHOWN FOR REFERENCE. CM TO CONTROL TEMPORARY BARRIER LOCATIONS. WORK BY GENERAL TRADES.
- A6 TEMPORARY LOCKERS
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SECURITY HARDWARE

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- INTERCOM SUB STATION WITH VIDEO CAMERA TO COMMUNICATE TO DEPARTMENT ENTRIES
- AUTOMATIC OPERATOR
- KEYPAD LOCK
- DOOR RELEASE BUTTON CONNECTION
- INTERCOM SUB STATION / PHONE TO COMMUNICATE WITHIN DEPARTMENT (TO SPEAKERS)
- CLOSER

LEVEL B DIMENSION PLAN AREA A.3
SCALE: 1/8" = 1'-0"

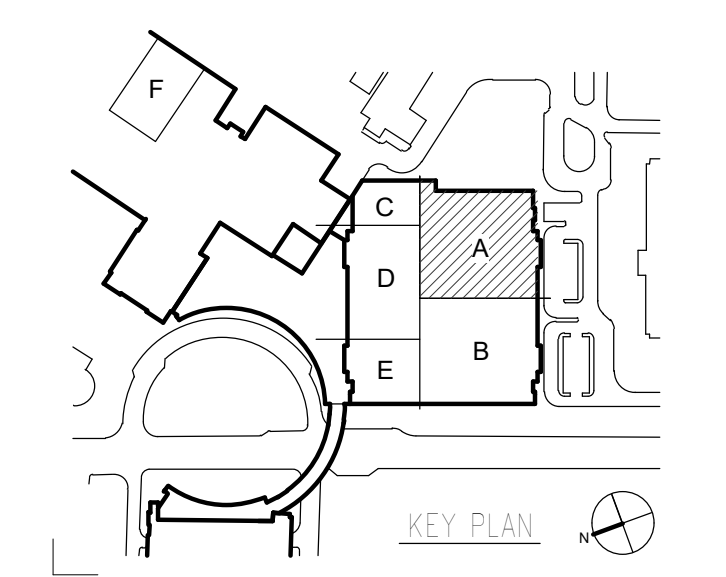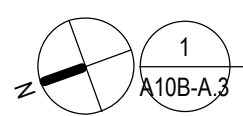

LEVEL B SUPPORT SERVICES RENOVATION | PAVILION A, 1000 S. LIMESTONE, LEXINGTON, KY 40536



PROJECT ARCHITECT
 609 West Main St.
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DRAWING ISSUE

CONTRACT DOCUMENTS

NO.	DATE	DESCRIPTION
1	05.20.22	CD/BD DOCUMENTS BP#2
2	09.20.22	BP2 ADDENDUM 6

DRAWING TITLE

LEVEL B DIMENSION PLAN - AREA A PHASE 4

SEAL



JOB NUMBER

14590.01

A10B-A.4

05/20/2022

GENERAL NOTES - FLOOR PLAN

- A. **LAYOUT AND DIMENSIONS**
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- B. **PARTITION ALIGNMENT**
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PROVIDE NEW HARD-PIPED CONDUIT AND GYPSUM BOARD AT NEW DATA AND POWER LOCATIONS IN EXISTING WALLS.

PARTITION AND WALL GRAPHIC KEY

- NON-RATED PARTITION
- NON-RATED PARTITION (EXISTING)
- 1 HOUR FIRE BARRIER
- 1 HOUR FIRE BARRIER (EXISTING)
- 2 HOUR FIRE BARRIER
- 2 HOUR FIRE BARRIER (EXISTING)
- 1 HOUR FIRE AND SMOKE BARRIER
- 1 HOUR FIRE AND SMOKE BARRIER (EXISTING)
- 2 HOUR FIRE AND SMOKE BARRIER
- 2 HOUR FIRE AND SMOKE BARRIER (EXISTING)
- SMOKE RESISTING PARTITION
- SMOKE RESISTING PARTITION (EXISTING)
- 1 HOUR SMOKE BARRIER
- 1 HOUR SMOKE BARRIER (EXISTING)

PARTITION TAG GRAPHIC KEY

- FIRE ASSEMBLY RATING (HOURS) OR SMOKE PARTITION REQUIREMENT
- PARTITION TYPE - REFER TO SHEET A601
- PARTITION WALL MODIFICATION


AREA NOT IN SCOPE

KEYNOTE


- A5 TEMPORARY WALL SHOWN FOR REFERENCE. CM TO CONTROL TEMPORARY BARRIER LOCATIONS; WORK BY GENERAL TRADES.
- A8 TEMPORARY DOOR SHOWN FOR REFERENCE. CM TO CONTROL TEMPORARY BARRIER LOCATIONS; WORK BY GENERAL TRADES.

SECURITY HARDWARE

- WALL MOUNTED CARD READER
- INTERCOM SUB STATION WITH VIDEO CAMERA TO COMMUNICATE TO DEPARTMENT ENTRIES
- AUTOMATIC OPERATOR
- KEYPAD LOCK
- DOOR RELEASE BUTTON CONNECTION
- INTERCOM SUB STATION / PHONE TO COMMUNICATE WITHIN DEPARTMENT (TO SPEAKERS)
- CLOSER

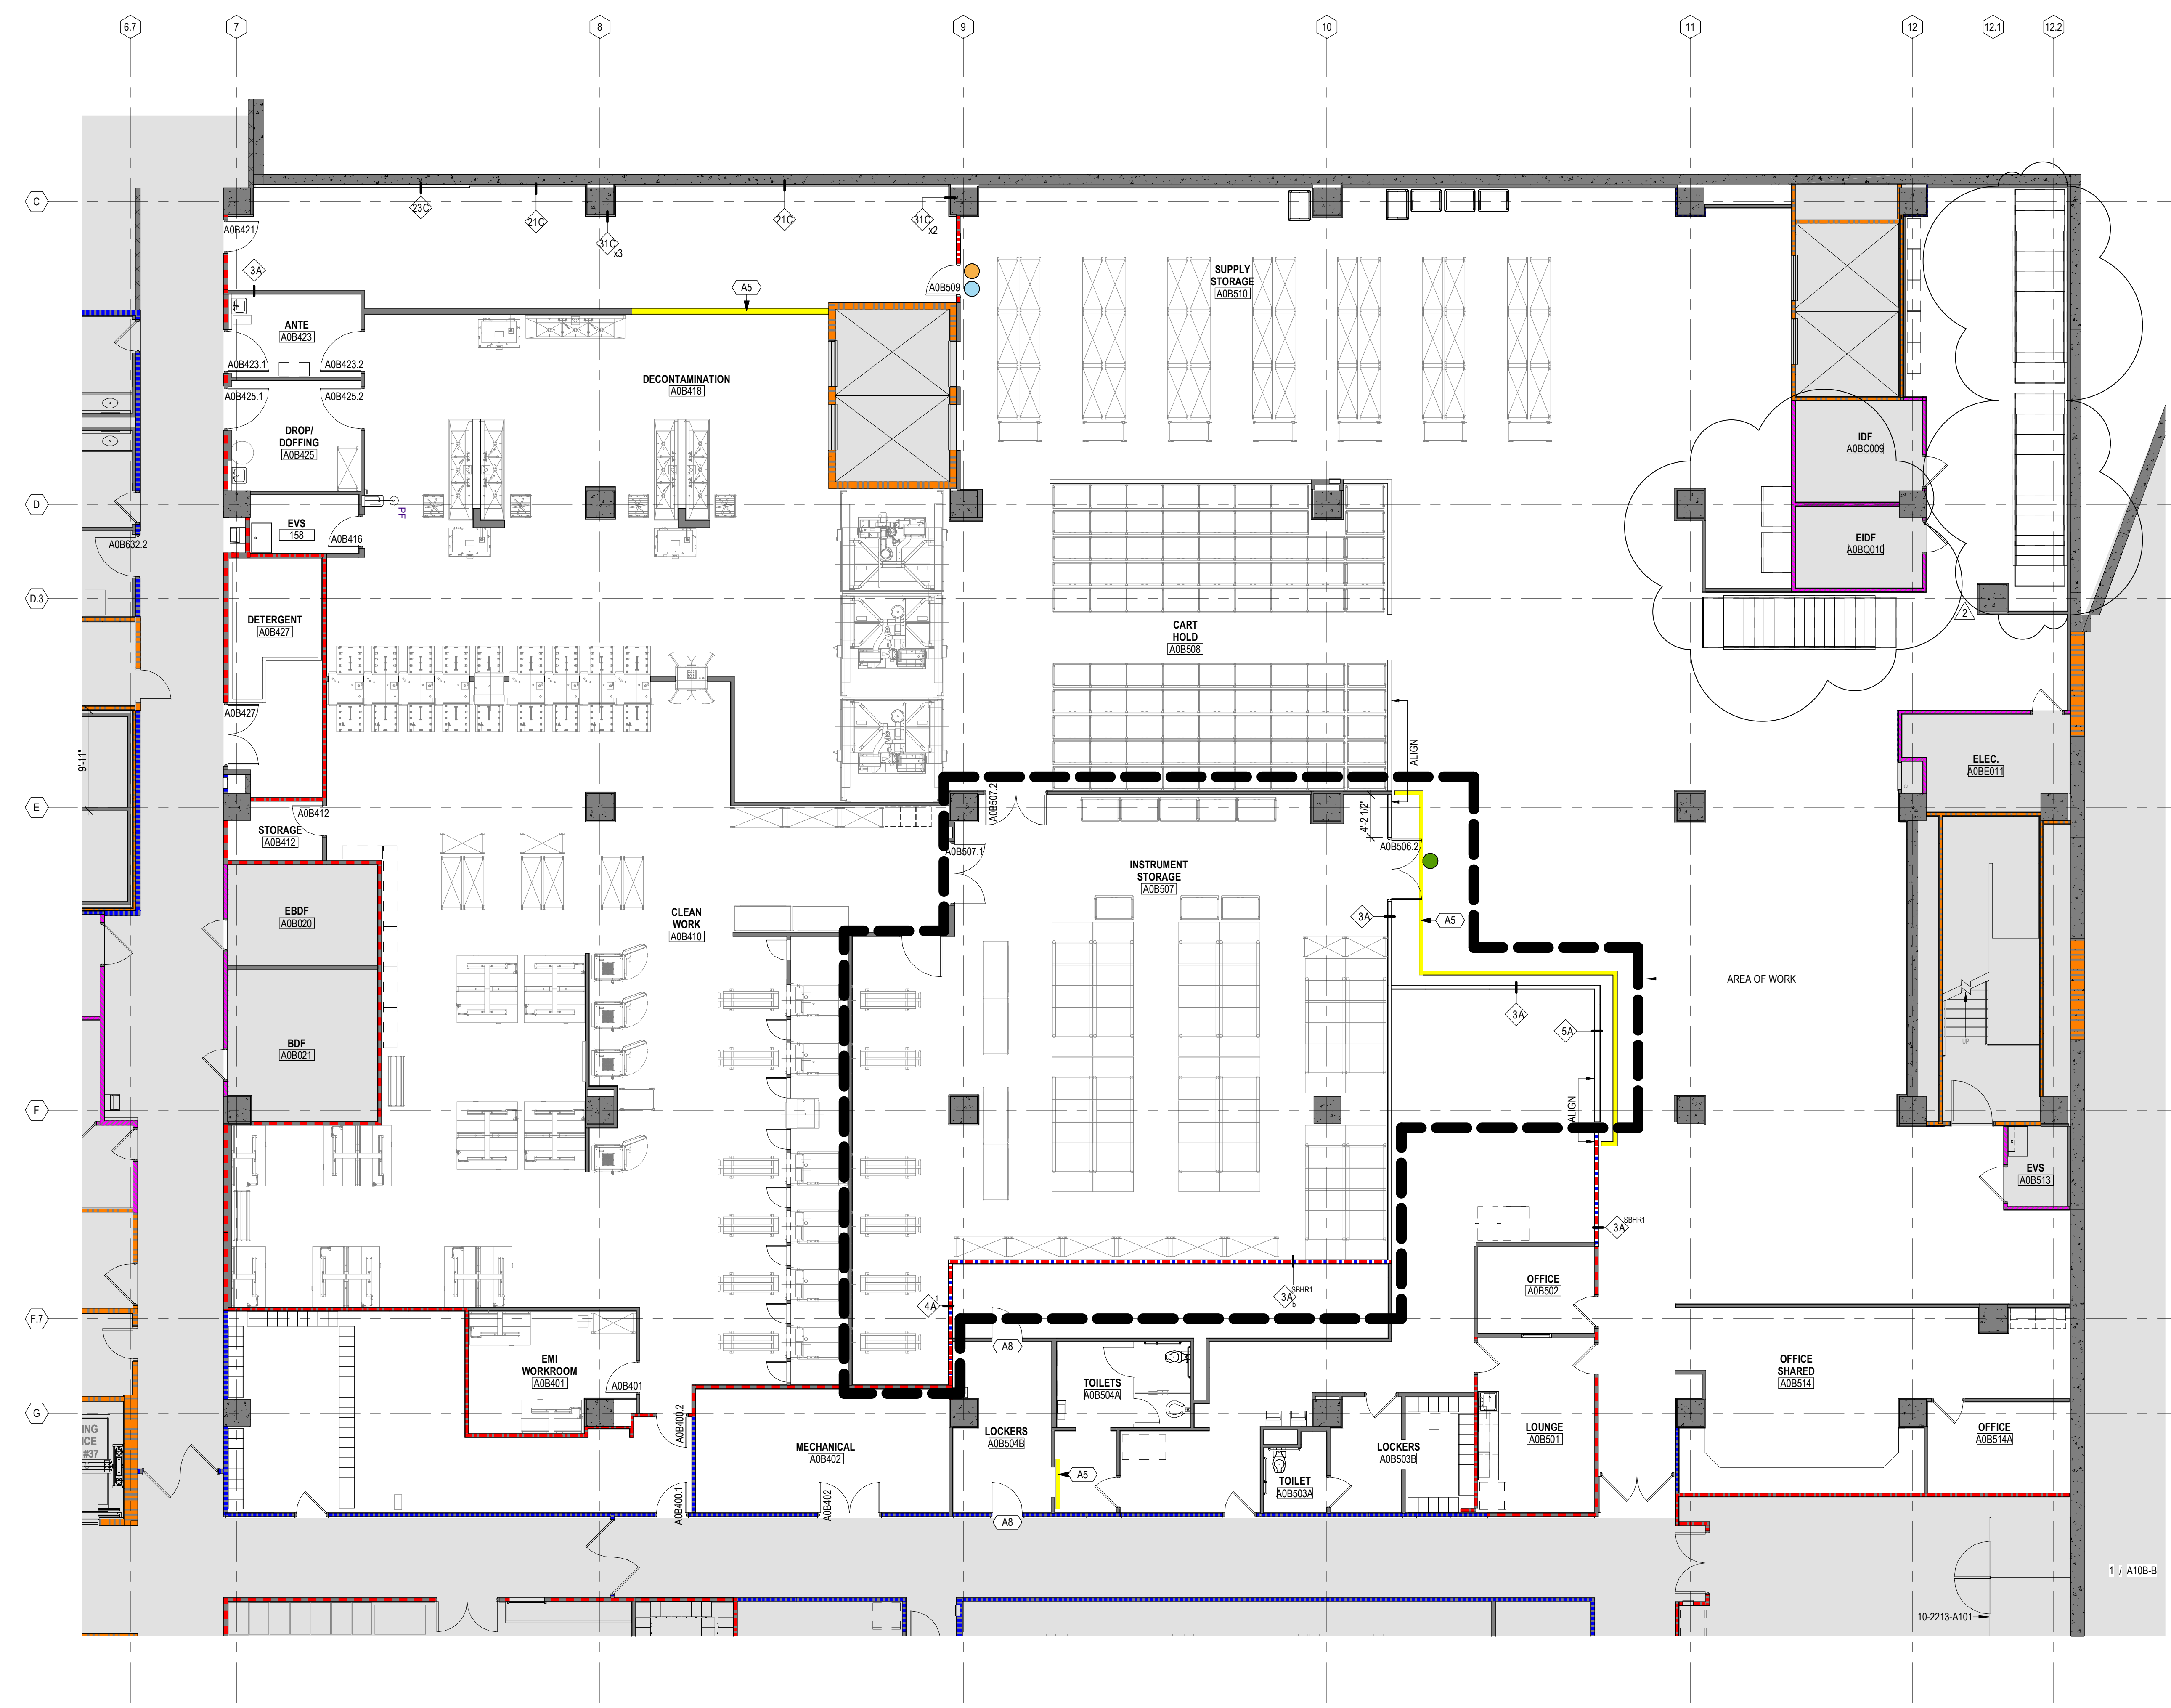

LEVEL B DIMENSION PLAN AREA A.4
 SCALE: 1/8" = 1'-0"

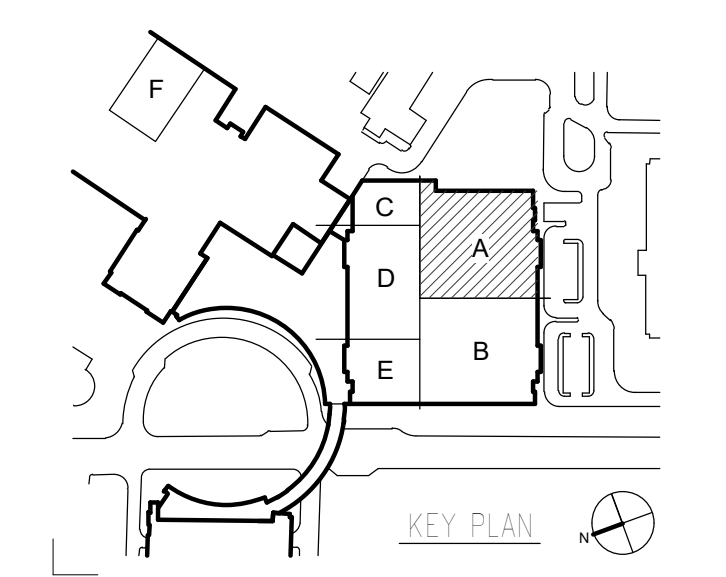

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LEVEL B SUPPORT SERVICES RENOVATION | PAVILION A, 1000 S. LIMESTONE, LEXINGTON, KY 40536



PROJECT ARCHITECT
 332 E. 8th ST.
 Cincinnati, OH 45202-2217
 v 513.241.8700
 GBBN.COM



Renovate / Upgrade
 UK Healthcare
 Facilities
 Pavilion A Level B
 Project Number:
 2239.77

OWNER

University of Kentucky

222 Peterson Service Building
 Lexington, KY 40506

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DRAWING ISSUE


CONTRACT DOCUMENTS

NO	DATE	DESCRIPTION
1	05.20.22	CD/BID DOCUMENTS BP#2
2	9.20.22	BP2 - ADD#6

DRAWING TITLE

**LEVEL 0B - POWER -
 NEW WORK - AREA A -
 PHASE 5**

SEAL

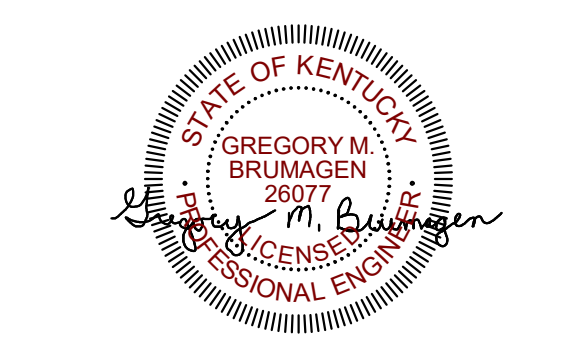

JOB NUMBER


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E55B-A


02/04/2022

TAGGED NOTES

- E95 EXISTING CONDUIT RACK TO REMAIN.
- E102 MOUNT DUPLEX ON WALL ABOVE UNIT. POWER CONNECTION FROM UNIT COMES FROM TOP.
- E103 COORDINATE RECEPTACLE LOCATION WITH MONITORMOUNT PRIOR TO ROUGH IN.
- E106 PLACE DISCONNECT ON EMERGENCY POWER BUS DUCT AND RUN FEEDER TO TRANSFORMER BCHTA2 IN MECHANICAL ROOM A0B402. REFER TO ONE-LINE DIAGRAM ON SHEET E718 FOR ADDITIONAL INFORMATION.
- E143 CONTRACTOR TO TAKE EXTRA MEASURES TO ENSURE DUST/DEBRIS DOES NOT ENTER COMMUNICATIONS ROOMS DURING CONSTRUCTION. COMMUNICATIONS ROOMS SHALL REMAIN UP AND RUNNING THE FULL DURATION OF CONSTRUCTION.
- E145 NO WORK IN HATCHED AREA FOR BID PACK 2.
- E149 PROVIDE 120V CONNECTION FOR TRAP PRIMER. COORDINATE LOCATION WITH MECHANICAL DRAWINGS PRIOR TO ROUGH-IN.

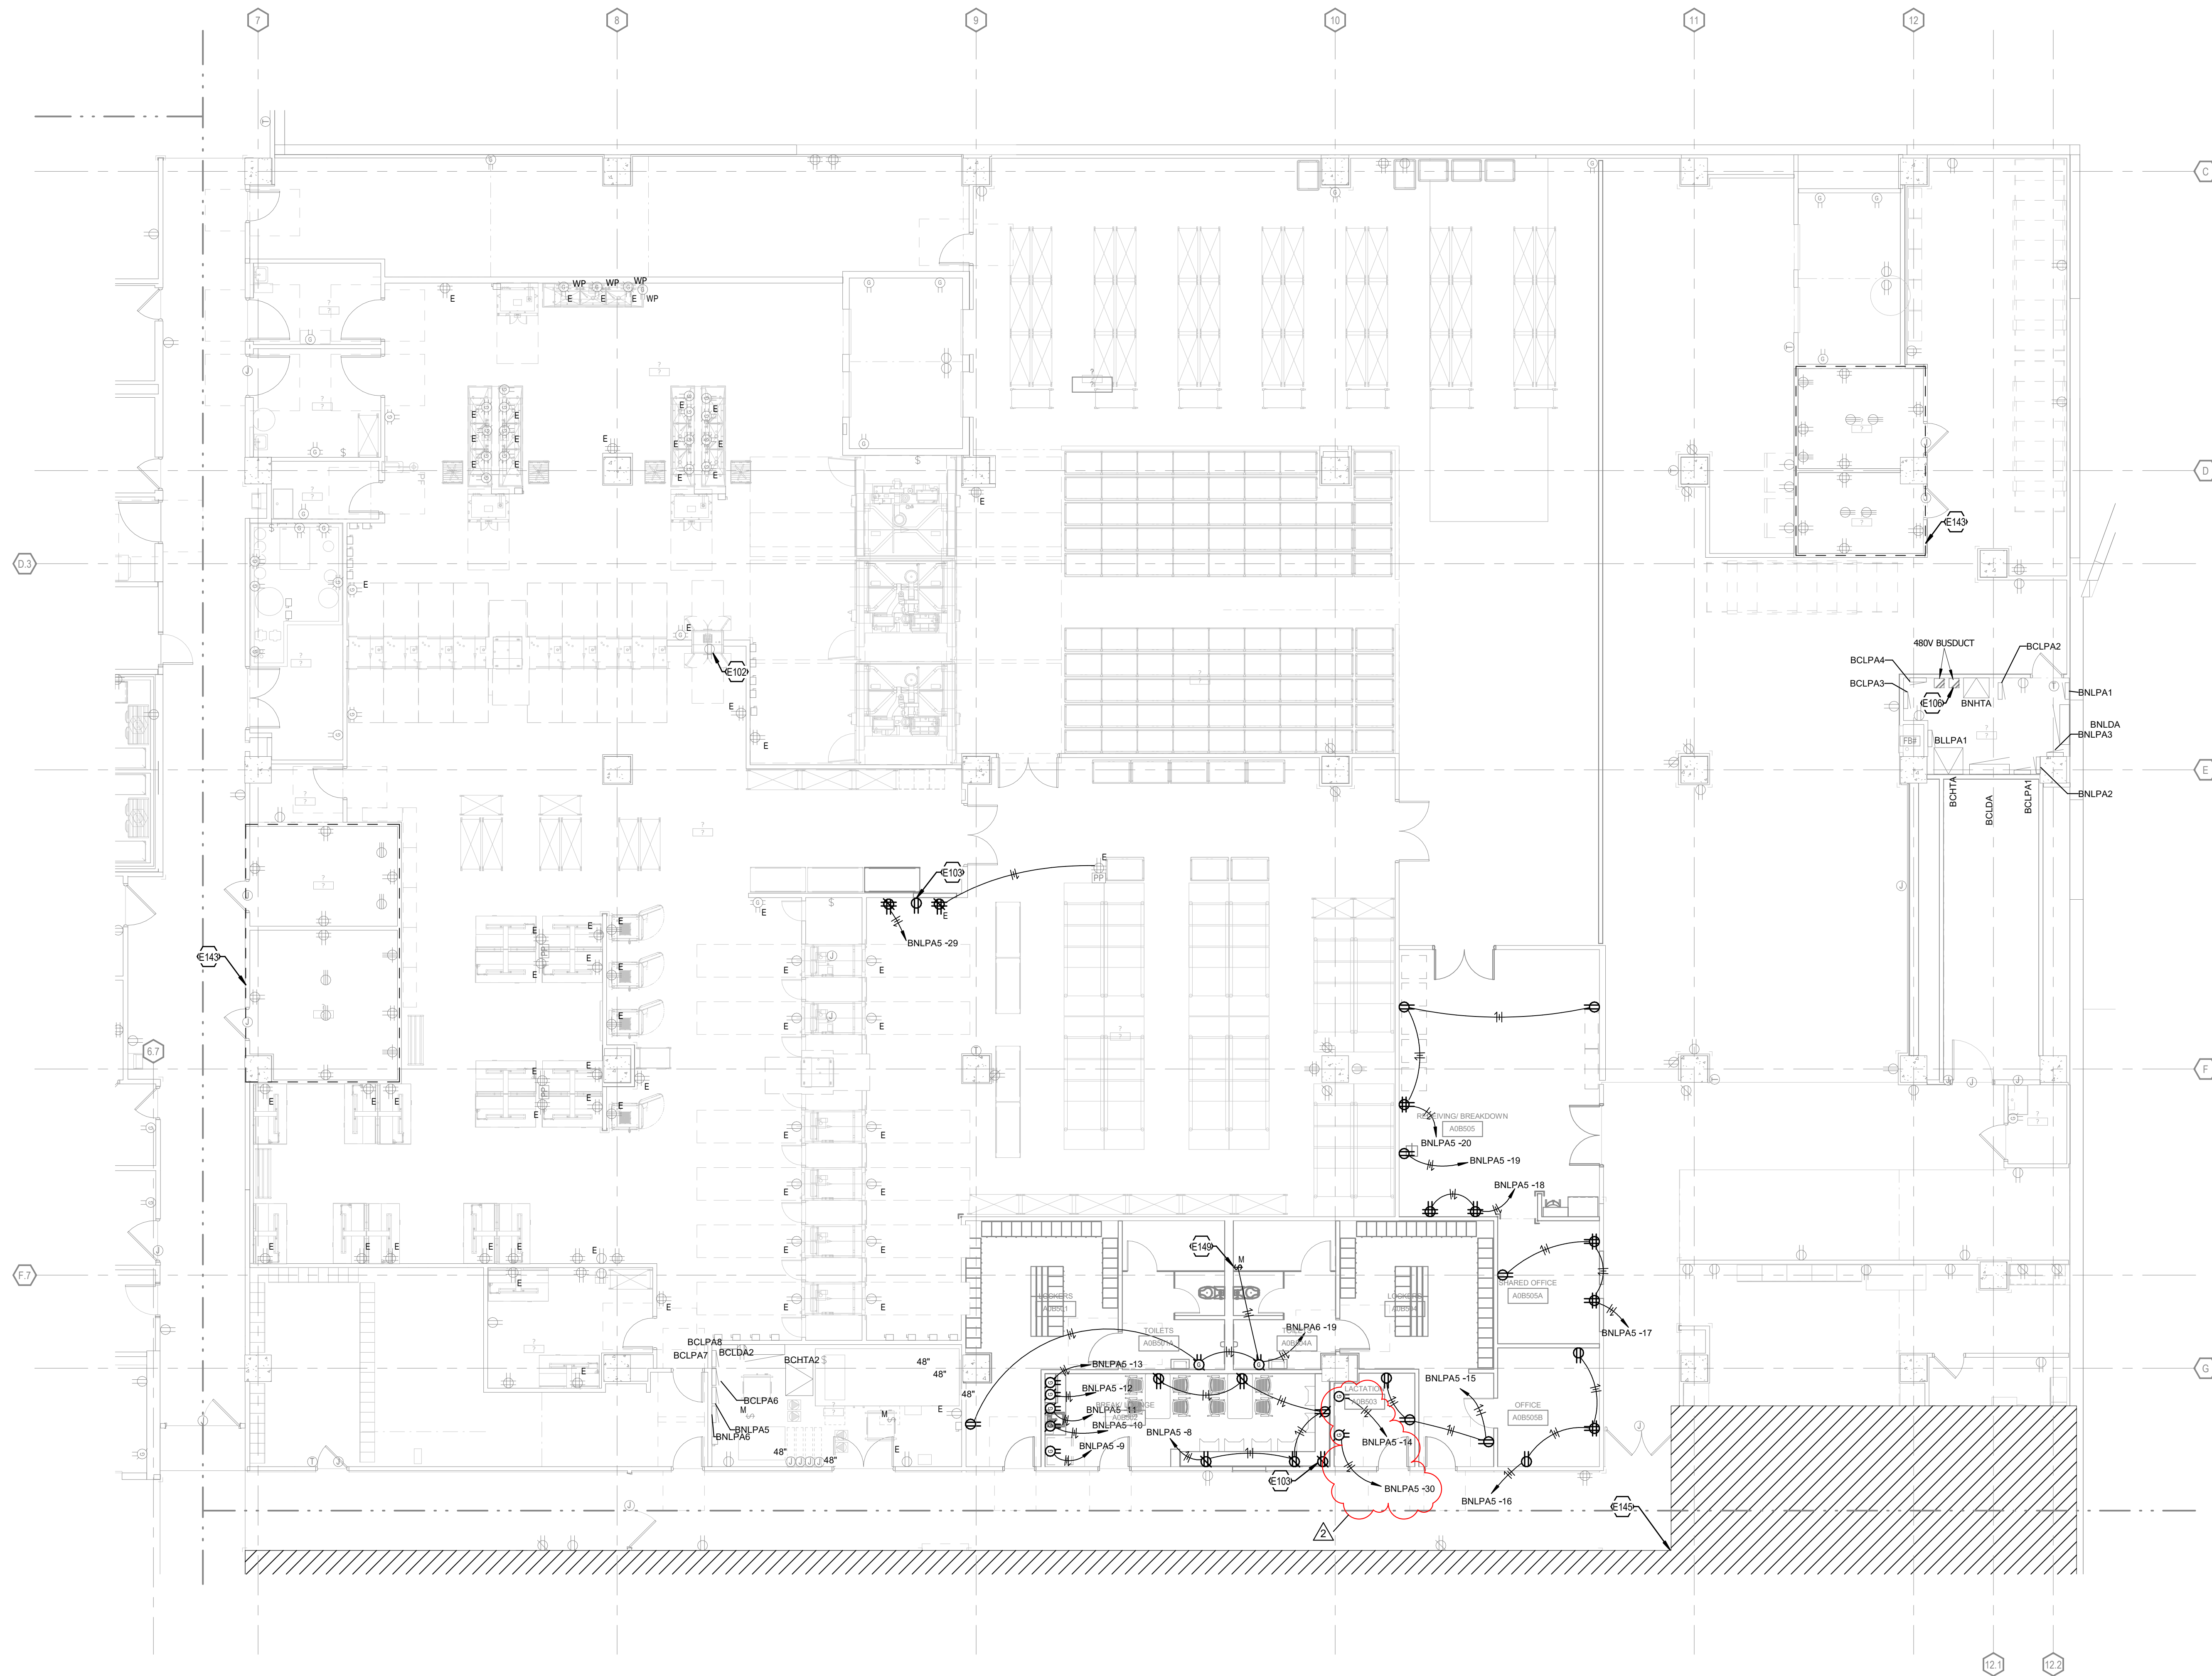

**LEVEL 0B - NEW WORK - POWER - AREA A -
 PHASE 2.5**
 SCALE: 1/8" = 1'-0"
 0 2 4 8 16 24 32

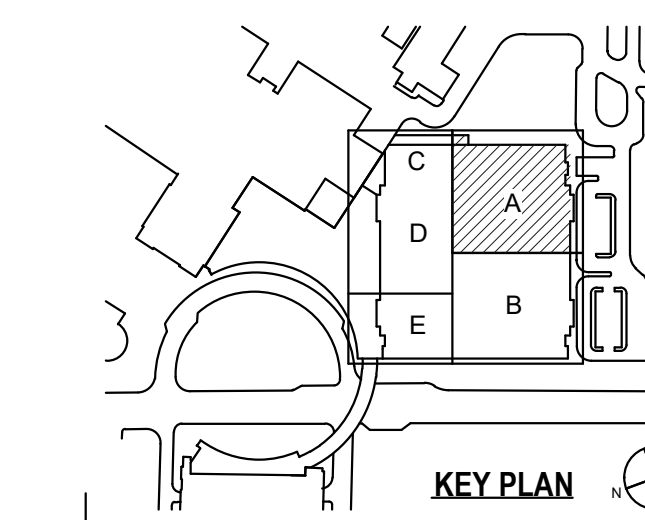

KITCHEN - ADDITIONAL TRENCH DRAIN | PAVILION A, 1000 S. LIMESTONE, LEXINGTON, KY 40536



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 332 E. 8th ST.
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 GBBN.COM



Renovate / Upgrade
 UK Healthcare
 Facilities
 Pavilion A Level B
 Project Number:
 2239.77

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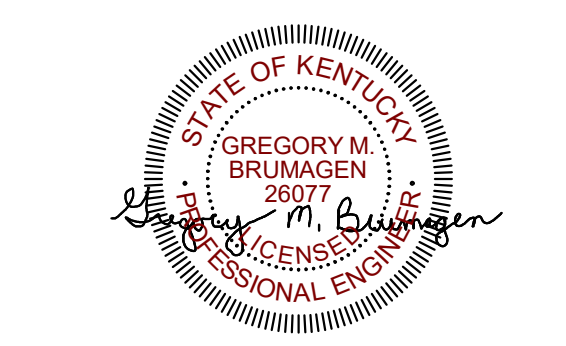
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CONTRACT DOCUMENTS

NO.	DATE	DESCRIPTION
1	05.20.22	CD/BID DOCUMENTS BP#2
2	9.13.22	BP2- ADD#3
3	9.20.22	BP2- ADD#6

DRAWING TITLE
LEVEL 0B - POWER -
NEW WORK - AREA A -
PHASE 6

SEAL



JOB NUMBER


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E56B-A



02/04/2022

TAGGED NOTES

- E105 EXISTING CONDUIT RACK TO REMAIN.
- E103 COORDINATE RECEPTACLE LOCATION WITH MONITOR/MOUNT PRIOR TO ROUGH IN.
- E105 NEMA 5-15R RECEPTACLE TO BE MOUNTED ABOVE MEDIATOR ENDOSCOPE SYSTEM. COORDINATE LOCATION WITH EQUIPMENT VENDOR PRIOR TO ROUGH IN.
- E106 PLACE DISCONNECT ON EMERGENCY POWER BUSDUCT AND RUN FEEDER TO TRANSFORMER BCHTA2 IN MECHANICAL ROOM A8B402. REFER TO ONE-LINE DIAGRAM ON SHEET E71B FOR ADDITIONAL INFORMATION.
- E109 COORDINATE RECEPTACLE HEIGHT AND LOCATION WITH UNDERCOUNTER FRIDGE PRIOR TO ROUGH-IN.
- E110 COORDINATE RECEPTACLE HEIGHT AND LOCATION WITH COFFEE MAKER PRIOR TO ROUGH-IN.
- E139 COORDINATE RECEPTACLE HEIGHTS WITH SINK EQUIPMENT. LOCATIONS ABOVE BACKSPASH. RECEPTACLES SHALL BE MOUNTED IN WALL ABOVE 4'-6" AFF TO ACCOMMODATE TALLEST SINK HEIGHT.
- E143 CONTRACTOR TO TAKE EXTRA MEASURES TO ENSURE DUST/DEBRIS DOES NOT ENTER COMMUNICATIONS ROOMS DURING CONSTRUCTION. COMMUNICATIONS ROOMS SHALL REMAIN UP AND RUNNING THE FULL DURATION OF CONSTRUCTION.
- E144 COORDINATE RECEPTACLE HEIGHT AND LOCATION GENSTRAC MONITOR PRIOR TO ROUGH-IN. REFER TO ARCHITECTURAL SHEETS FOR ADDITIONAL INFORMATION.
- E145 NO WORK IN HATCHED AREA FOR BID PACK 3.
- E147 RECEPTACLE TO BE MOUNTED INSIDE WALL BOX BEHIND DISPLAY.
- E149 PROVIDE 120V CONNECTION FOR TRAP PRIMER. COORDINATE LOCATION WITH MECHANICAL DRAWINGS PRIOR TO ROUGH-IN.
- E153 FLOORBOX SHALL CONTAIN QUAD FOR POWER, 2D DATA DROP, HDMI CONNECTION PORT. RUN (1) 1/4" CONDUIT FROM FLOORBOX TO DISPLAY WITH PULL STRING FOR FUTURE AV CONNECTION. (1) 3/4" CONDUIT FROM FLOOR BOX TO WALL AND MAKE CIRCUIT CONNECTION TO DISPLAY. (2) 1" CONDUIT FROM FLOORBOX TO WALL AND UP TO NEAREST CABLE TRAY FOR DATA CABLES. SEE DETAIL #5 ON ELECTRICAL SHEET E708-A FOR ADDITIONAL DETAILS. FLOORBOX SHALL BE LEGRAND WIREMOLD EVOLUTION SERIES.
- E156 EXTEND EXISTING CIRCUIT TO NEW RECEPTACLE LOCATION. REFER TO DEMOLITION PLAN FOR PREVIOUS LOCATION.
- E159 POWER TO BE INSPIRED IN OFFER SOLUTION FOR AV SYSTEMS. REFER TO CONFERENCE ROOM DETAIL ON SHEET E708-A.
- E167 COORDINATE DUPLEX AND CIRCUIT LOCATION WITH COUNTERTOP REFRIGERATOR PRIOR TO ROUGH-IN.

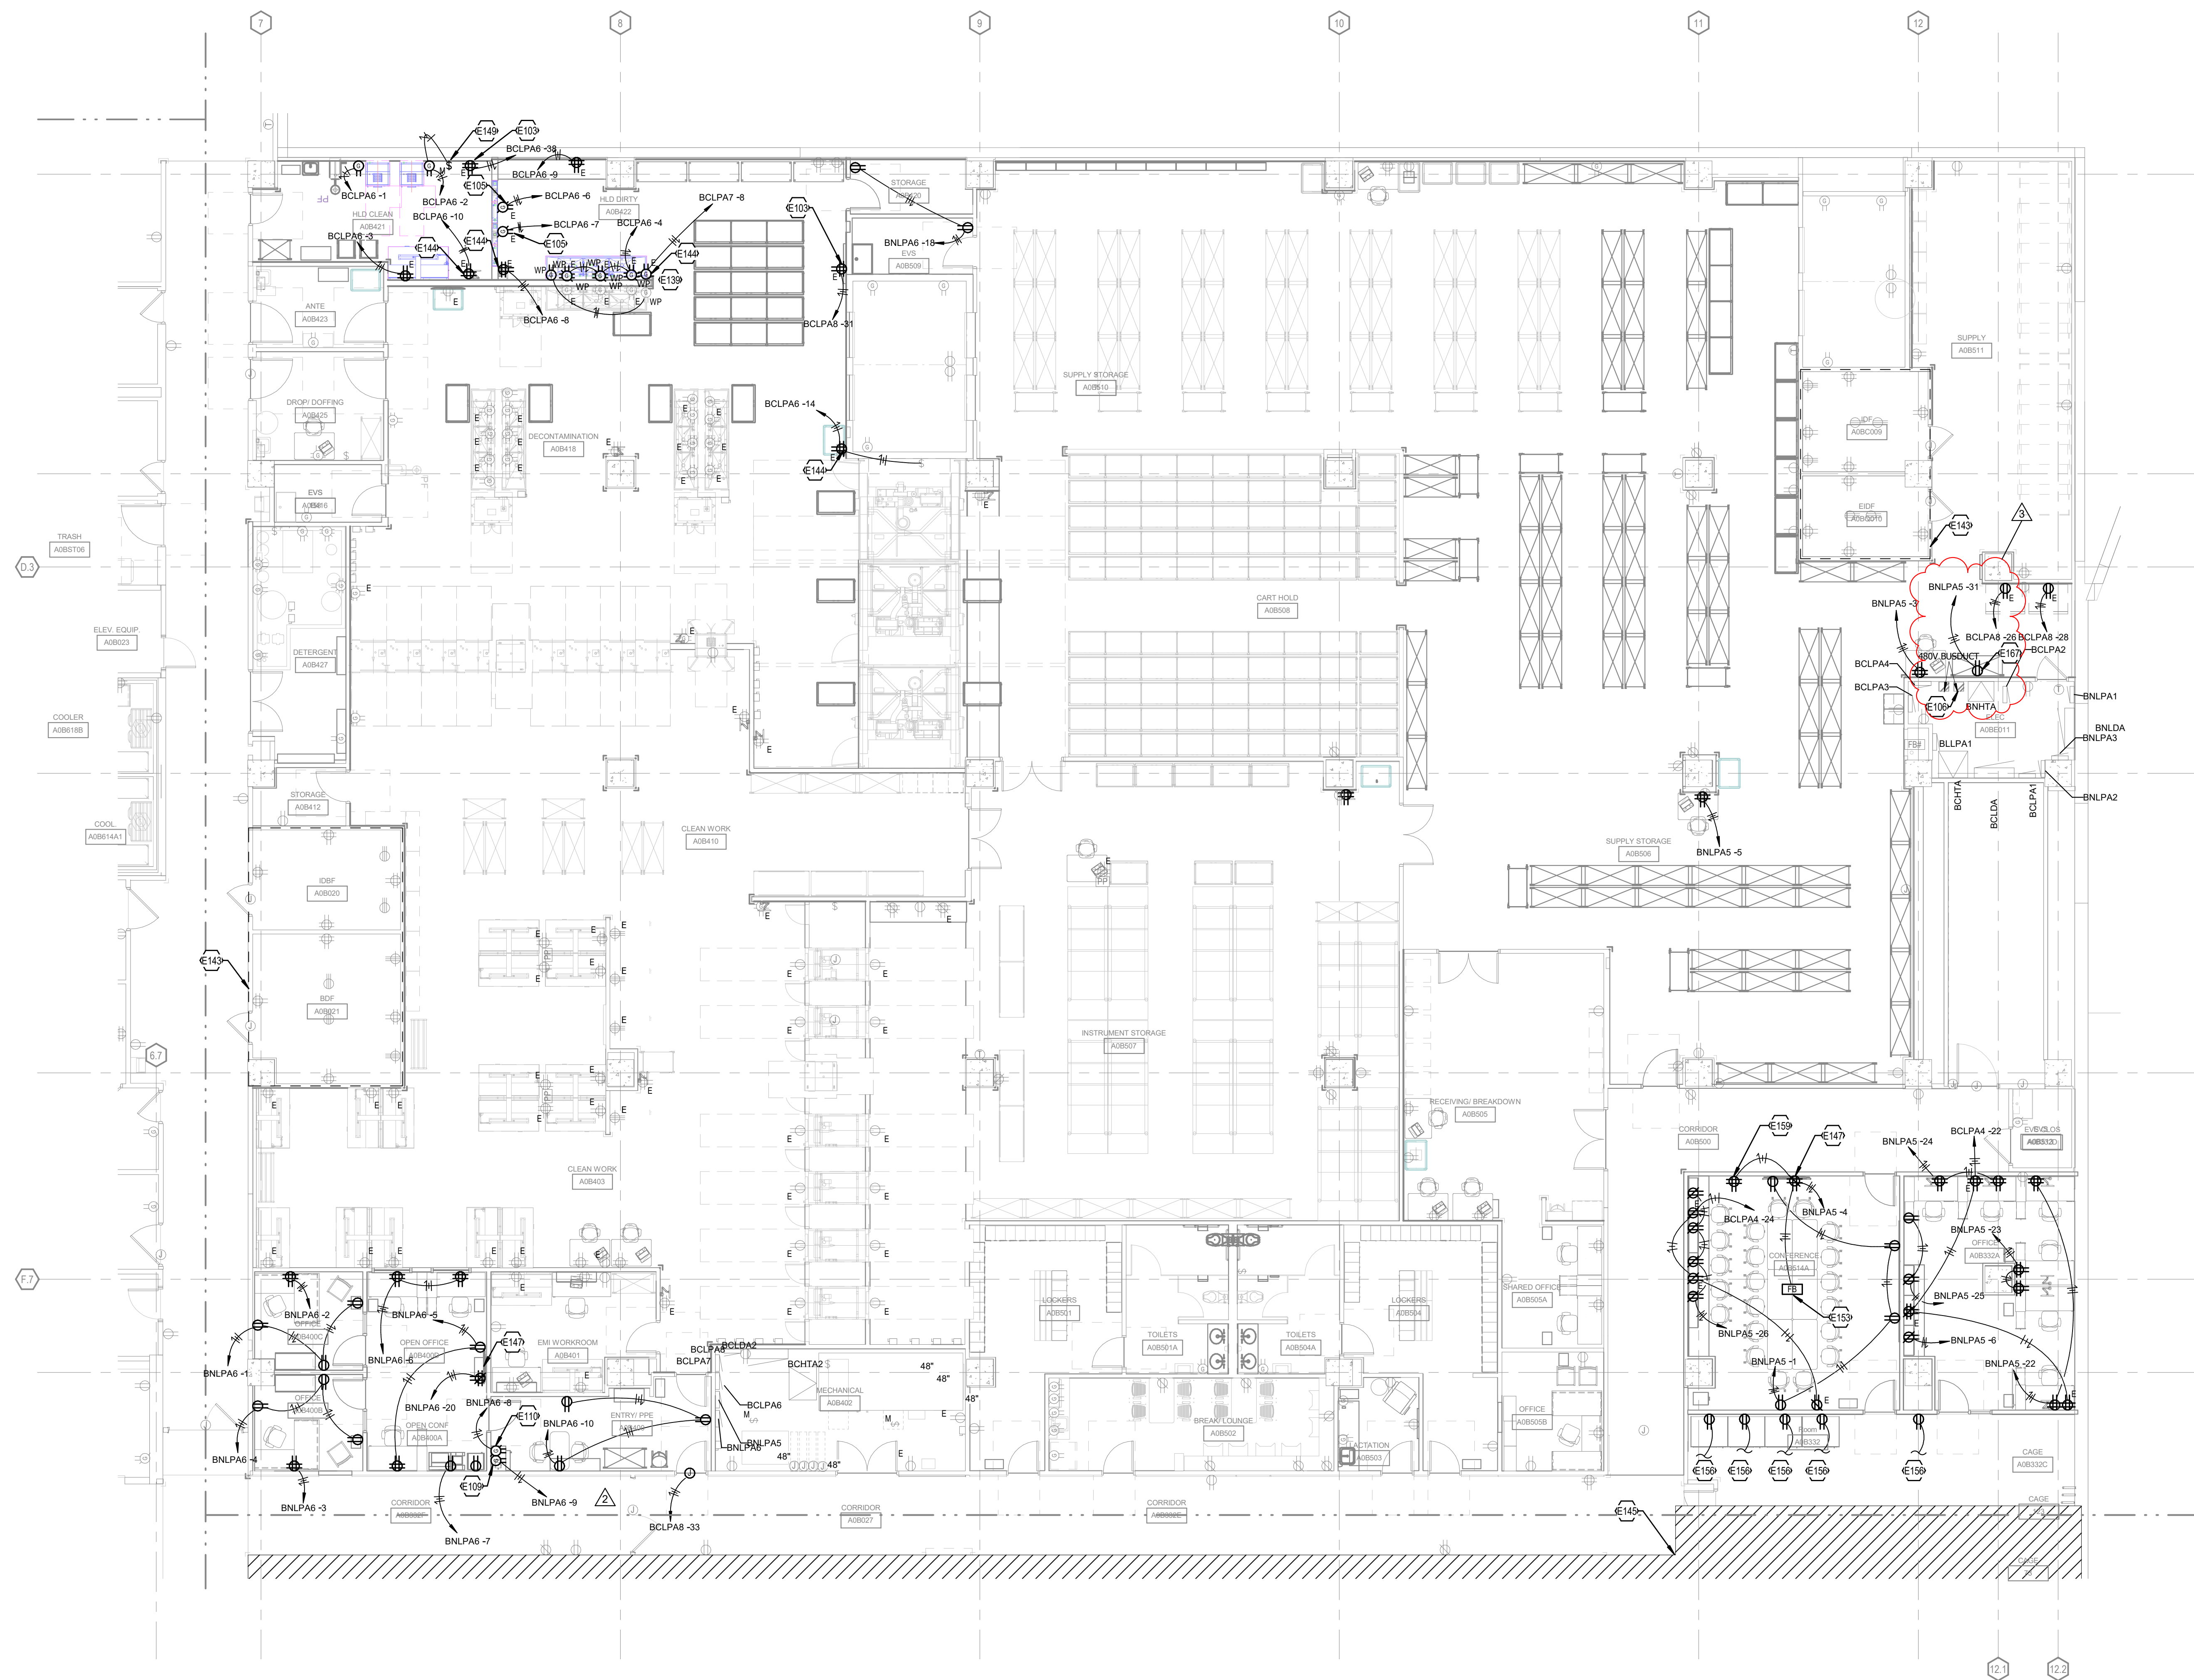

LEVEL 0B - NEW WORK - POWER - AREA A - PHASE 2.6

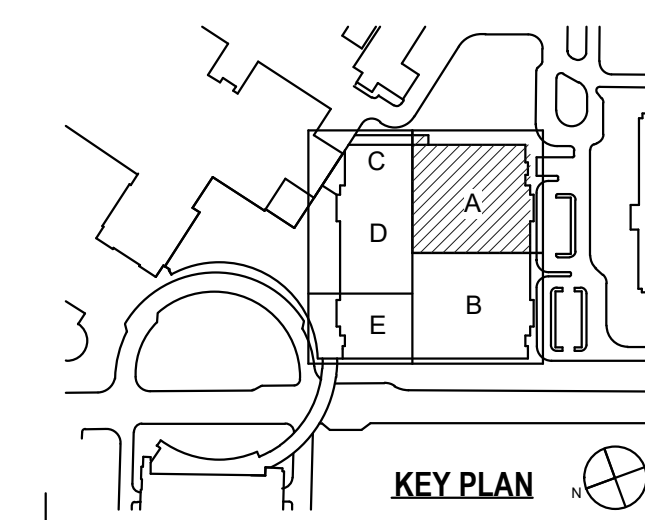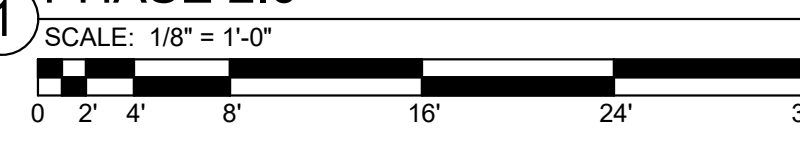

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KITCHEN - ADDITIONAL TRENCH DRAIN | PAVILION A, 1000 S. LIMESTONE, LEXINGTON, KY 40536



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UK HealthCare
 Renovate / Upgrade
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 Pavilion A Level B
 Project Number:
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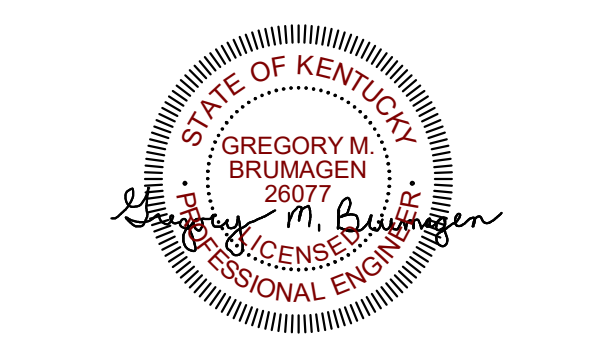
CONTRACT DOCUMENTS

NO	DATE	DESCRIPTION
1	05.20.22	CD/BID DOCUMENTS BP#2
2	9.20.22	BP2 - ADD#6

DRAWING TITLE

LEVEL 0B - SYSTEMS - AREA A - PHASE 6

SEAL



JOB NUMBER


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E66B-A


02/04/2022

TAGGED NOTES

- S5 CONTRACTOR TO TAKE EXTRA MEASURES TO ENSURE DUST/DEBRIS DOES NOT ENTER COMMUNICATIONS ROOMS DURING CONSTRUCTION. COMMUNICATIONS ROOMS SHALL REMAIN UP AND RUNNING THE FULL DURATION OF CONSTRUCTION.
- S11 OWNER-PROVIDED DISPLAY AT THIS LOCATION.
- S15 COORDINATE DATA DROP HEIGHT AND LOCATION WITH MONITOR. CONFIRM POWER AND DATA ARE OF THE SAME HEIGHT AND SIDE-BY-SIDE PRIOR TO ROUGH-IN.
- S17 SEE DETAIL 6 ON SHEET E70B FOR ADDITIONAL INFORMATION REGARDING AV CONNECTIVITY IN THIS ROOM.
- S21 NO WORK IN HATCHED AREA FOR BID PACK 2.
- S25 INTERCOM MASTER STATION TO BE CABLED BACK TO IDF. UTILIZE CAT 6 CABLE IN CONDUIT TO NEAREST CABLE TRAY OR CONDUIT DIRECTLY BACK TO IDF.
- S27 COORDINATE DATA DROP HEIGHT AND LOCATION WITH CENSTRAC. CONFIRM POWER AND DATA ARE OF THE SAME HEIGHT AND SIDE-BY-SIDE PRIOR TO ROUGH-IN.
- S28 COORDINATE DATA CONNECTION WITH EQUIPMENT INSTALLER PRIOR TO ROUGH-IN.
- S31 DATA DROP FOR CEILING MOUNTED SPEAKERS. SPEAKERS PROVIDED BY OWNER. COORDINATE DATA DROP LOCATION WITH OWNER SPEAKERS PRIOR TO ROUGH-IN.
- S32 DATA DROP FOR FUTURE CEILING MOUNTED SPEAKERS.
- S33 REFER TO POWER PLAN FOR FLOOR BOX COORDINATION. FLOOR BOX TO HAVE 2 DATA DROPS. INSTALL TWO (2) 1-1/2" CONDUITS TO WALL BOX (EFS84) BEHIND SCREEN WITH FULL STRINGS.
- S42 PROVIDE DATA DROPS, QUANTITY AS INDICATED AT THIS LOCATION FOR OWNER-PROVIDED DISPLAY. COORDINATE HEIGHT WITH DISPLAY. DROPS TO BE INSTALLED IN EFS84 BOX BEHIND DISPLAY. REFER TO DETAIL SHEET FOR ADDITIONAL INFORMATION.
- S43 PROVIDE CHIEF PAC526 WALL ENCLOSURE AT THIS LOCATION FOR CONNECTION TO DISPLAY. SEE CONFERENCE ROOM AV RISER ON SHEET E70B-A FOR ADDITIONAL INFORMATION INCLUDING MOUNTING HEIGHT, POWER REQUIREMENTS AND PATHWAYS.
- S44 CENTER CAMERA ON WALL ABOVE DISPLAY. REFER TO CONFERENCE ROOM AV RISER DETAIL ON SHEET E70B-A FOR ADDITIONAL INFORMATION.
- S45 CENTER CAMERA ON BACK WALL OF ROOM. REFER TO CONFERENCE ROOM AV RISER DETAIL ON SHEET E70B-A FOR ADDITIONAL INFORMATION INCLUDING MOUNTING HEIGHT AND ELECTRICAL ROUGH-IN.

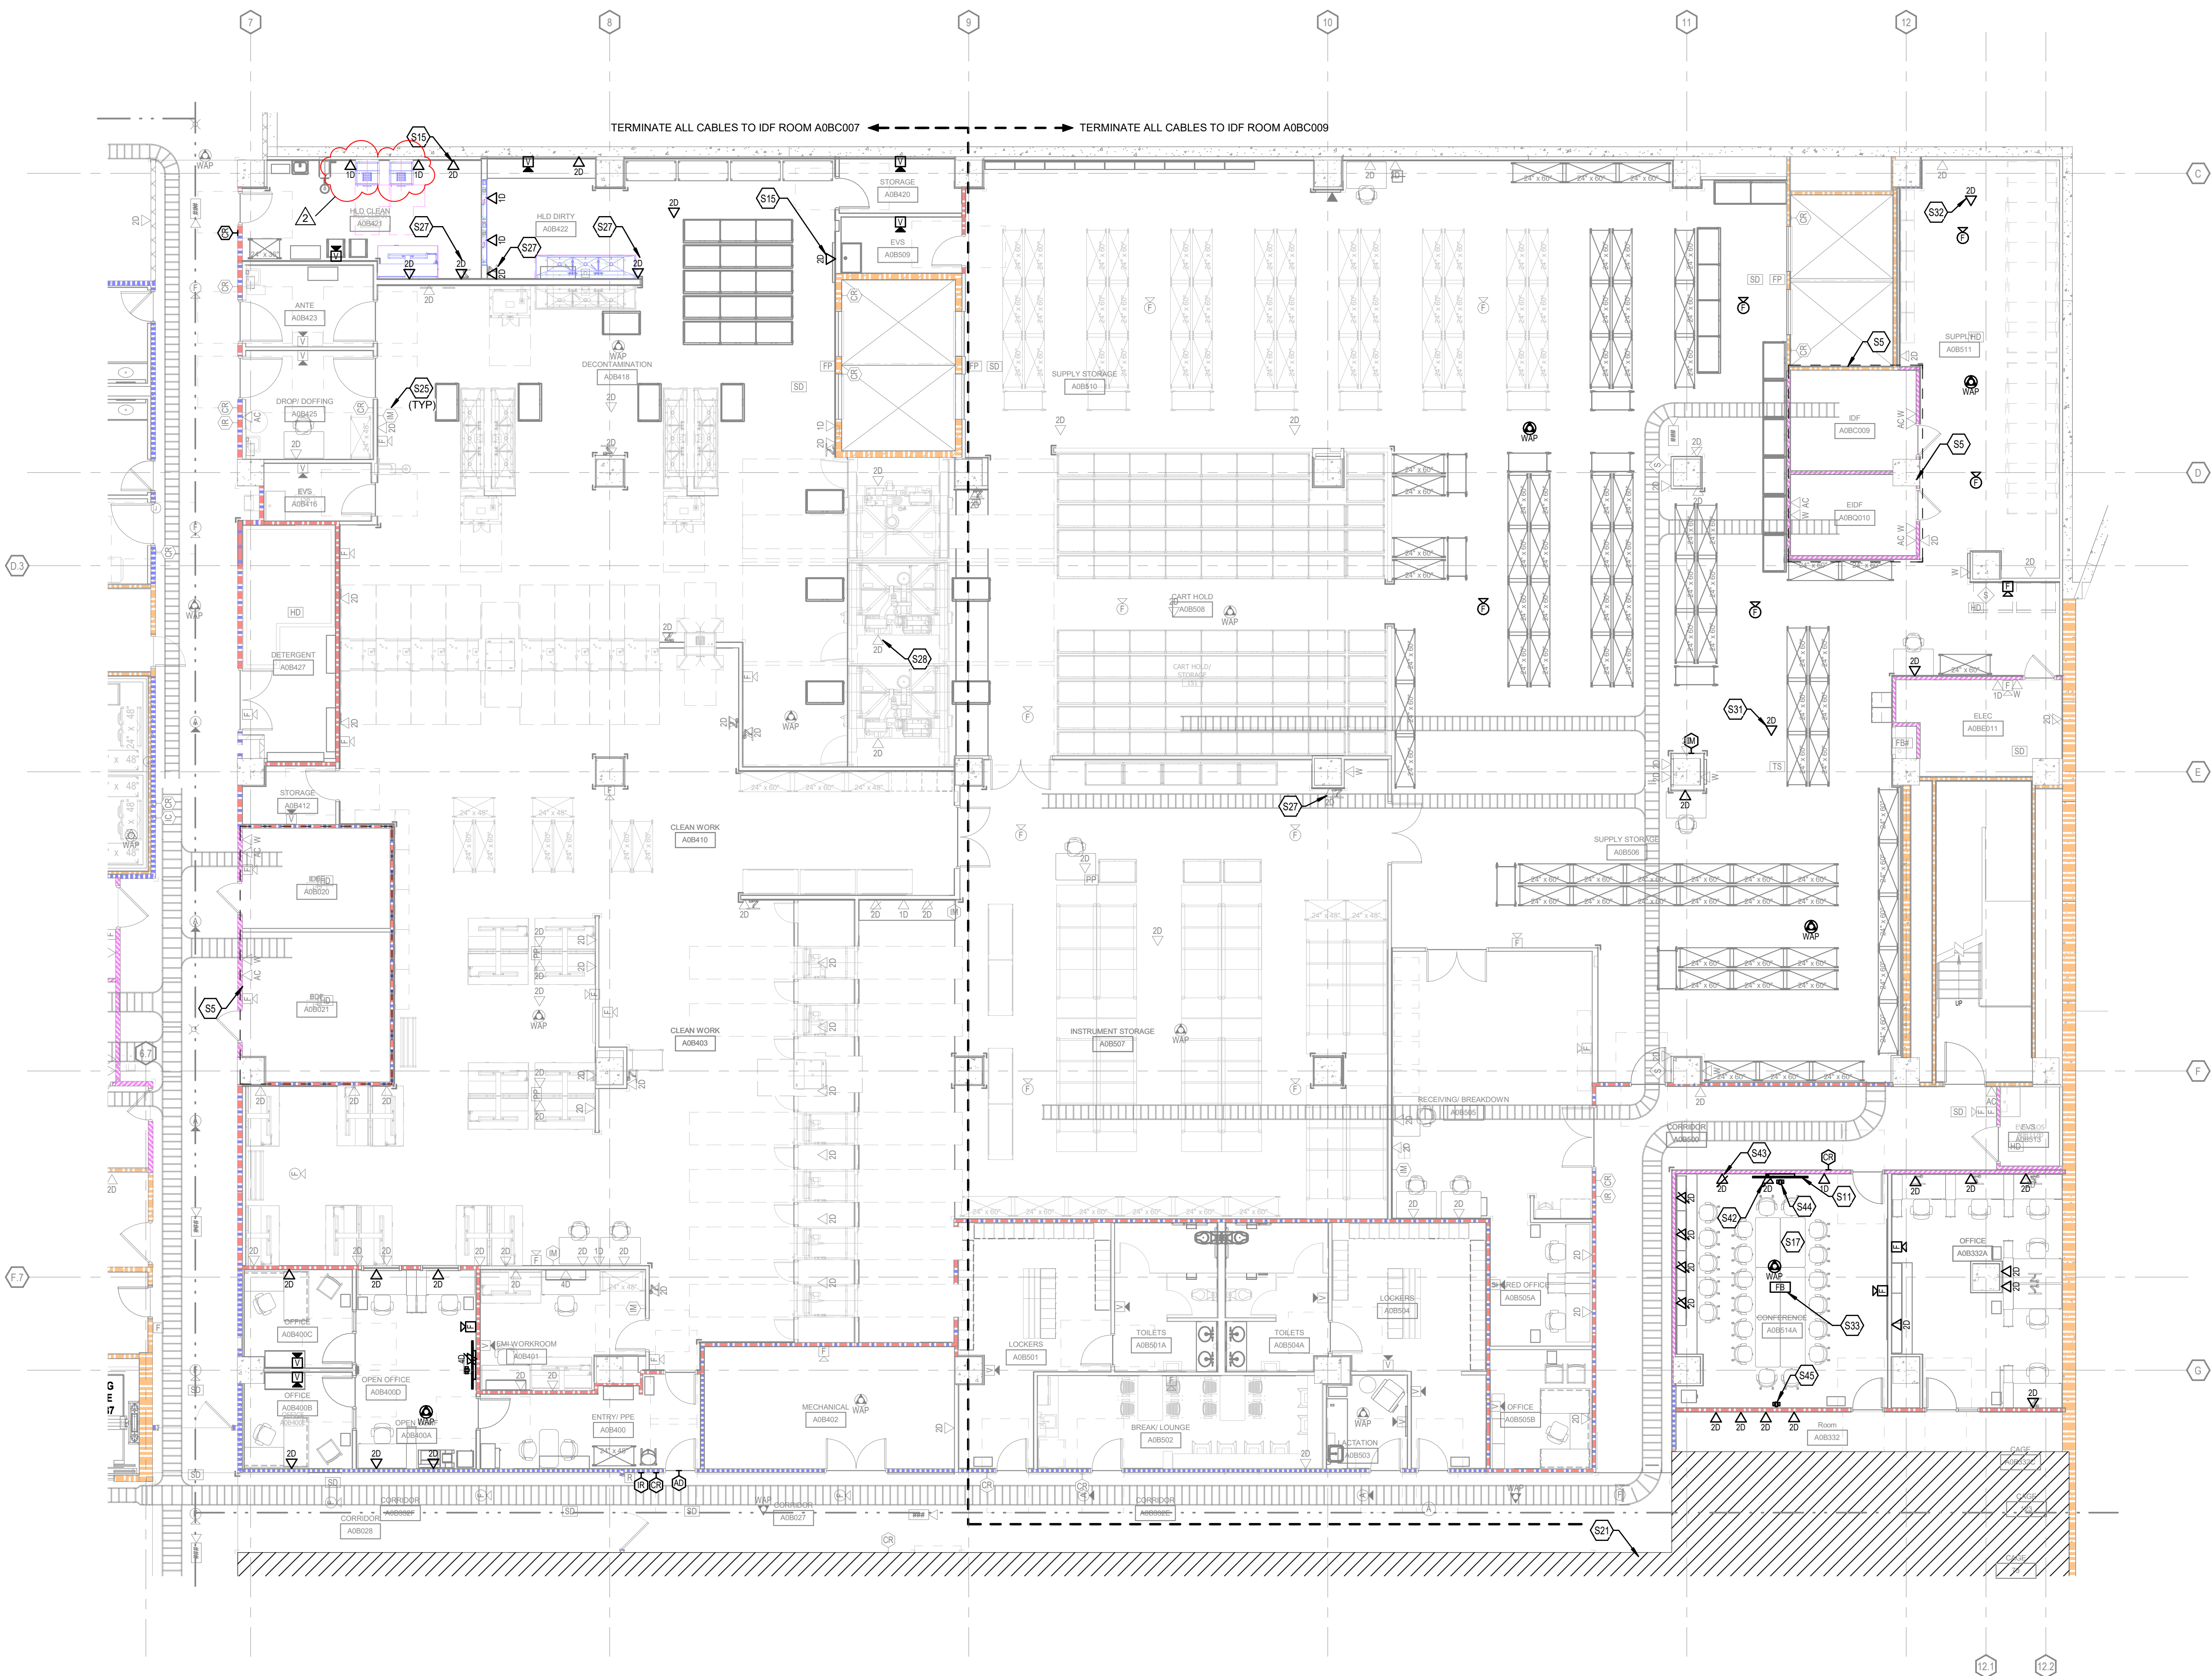

LEVEL 0B - NEW WORK - SYSTEMS - AREA A - PHASE 2.6
 SCALE: 1/8" = 1'-0"
 0 2 4 8 16 24 32

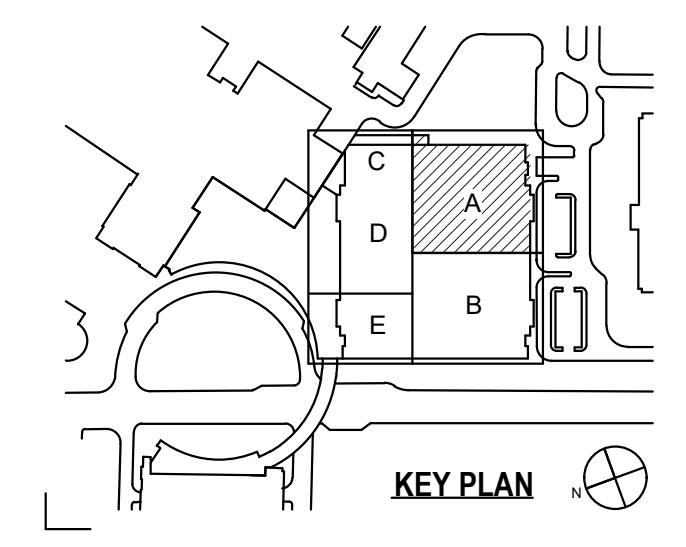

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KITCHEN - ADDITIONAL TRENCH DRAIN | PAVILION A, 1000 S. LIMESTONE, LEXINGTON, KY 40536

EXISTING PANEL
PANELBOARD AND WIRING SCHEDULE

PANEL: **BCLPA3**
VOLTAGE: 208Y/120V, 3P, 4W
AMPERES: 225 A

MAINS TYPE: MCB
SPD:
MOUNTING: SURFACE

PANEL INTERRUPTING RATING: <ENGINEER TO SPECIFY>
LOCATION: ELEC. A08E011
SUPPLY FROM:

NOTES	CIRCUIT DESCRIPTION	HOT, NEUT, GND	OCB	P	CKT	A	B	C	CKT	P	OCB	HOT, NEUT, GND	CIRCUIT DESCRIPTION	NOTES
	STERILIZER (208)	--	20	3	3	0.0	0.0	0.0	4	3	30	--	HP STERIL (208)	
	STERILIZER (208)	--	20	3	7	0.0	0.0	0.0	8	3	30	--	HP STERIL (208)	
	STERILIZER (208)	--	20	3	11	0.0	0.0	0.0	12	3	30	--	HP STERIL (208)	
	STERILIZER (208)	--	20	3	13	0.0	0.0	0.0	14	1	20	--	LTP STERIL (208)	
	STERILIZER (208)	--	20	3	15	0.0	0.0	0.0	16	1	20	--	LTP STERIL (208)	
	STERILIZER (208)	--	20	3	17	0.0	0.0	0.0	18	1	20	--	SPARE	
	STER REC (208)	--	20	1	19	0.0	0.0	0.0	20	3	30	--	SPARE	
	DECONTAMINATION	1-412, 1-412, 1-412	20	1	21	0.4	0.0	0.0	22	3	30	--	SPARE	
	DRIP TRAY	1-412, 1-412, 1-412	20	1	23	0.0	0.0	0.0	24	3	30	--	SPARE	
	SUPPORT FACILITIES	1-412, 1-412, 1-412	20	1	25	0.0	0.0	0.0	26	1	20	--	1-412, 1-412, 1-412 SUPPLY	
	AMSCO 600 ELECTRIC CONTROLS	1-412, 1-412, 1-412	20	1	27	0.0	0.5	0.0	30	1	20	--	AMSCO 600 ELECTRIC CONTROLS	
	SPARE	--	20	1	31	0.0	0.0	0.0	32	1	20	--	SPARE	
	SPARE	--	20	1	33	0.0	0.0	0.0	34	1	20	--	SPARE	
	SPARE	--	20	1	35	0.0	0.0	0.0	36	1	20	--	SPARE	
	SPARE	--	20	1	37	0.0	0.0	0.0	38	1	20	--	SPARE	
	SPARE	--	20	1	39	0.0	0.0	0.0	40	1	20	--	SPARE	
	SPARE	--	20	1	41	0.0	0.0	0.0	42	1	20	--	SPARE	
						0.1 kVA	1.0 kVA	1.3 kVA						
						9 A	28 A	30 A						

LOAD CLASSIFICATION CONNECTED LOAD DEMAND FACTOR ESTIMATED DEMAND PANEL TOTALS

EQUIP 1000 VA 100.00% 1000 VA TOTAL CONNECTED LOAD: 2309 VA

LING 1309 VA 100.00% 1309 VA TOTAL ESTIMATED DEMAND: 2309 VA

TOTAL CONNECTED CURRENT: 6 A
TOTAL ESTIMATED DEMAND CURRENT: 6 A
25 % ADDITIONAL CAPACITY: 2 A
TOTAL PANEL CURRENT: 6 A

NOTES: WHERE NOT LISTED, WIRE AND CONDUIT SHALL BE BE MINIMUM PER SPECIFICATIONS. SPARE BREAKERS TO BE 20A/1P.

PANELBOARD AND WIRING SCHEDULE

PANEL: **BCLPA6**
VOLTAGE: 208Y/120V, 3P, 4W
AMPERES: 400 A

MAINS TYPE: MCB
SPD:
MOUNTING: SURFACE

PANEL INTERRUPTING RATING: <ENGINEER TO SPECIFY>
LOCATION: CORRIDOR A08027
SUPPLY FROM: BCLDA

NOTES	CIRCUIT DESCRIPTION	HOT, NEUT, GND	OCB	P	CKT	A	B	C	CKT	P	OCB	HOT, NEUT, GND	CIRCUIT DESCRIPTION	NOTES
	AMSCO DRYING CABINET	1-412, 1-412, 1-412	20	1	1	0.2	0.2	0.0	2	1	20	1-412, 1-412, 1-412	AMSCO DRYING CABINET	
	AMSCO WORKSTATION HLD CLEAN	1-412, 1-412, 1-412	20	1	3	0.4	0.9	0.0	4	1	20	1-410, 1-410, 1-410	RECEPTS 3 COMP SINK HLD DIRTY	
	RECEPTS 3 COMP SINK DECONTAM	1-410, 1-410, 1-410	20	1	5	0.9	0.2	0.0	6	1	20	1-412, 1-412, 1-412	MEDEVATOR HLD DIRTY	
	MEDEVATOR HLD DIRTY	1-412, 1-412, 1-412	20	1	7	0.2	0.2	0.0	8	1	20	1-412, 1-412, 1-412	MONITOR HLD DIRTY	
	WORKSTATION HLD DIRTY	1-412, 1-412, 1-412	20	1	9	0.4	0.2	0.0	10	1	20	1-412, 1-412, 1-412	MONITOR HLD CLEAN	
	MONITOR DECONTAMINATION	1-412, 1-412, 1-412	20	1	11	0.4	0.9	0.0	12	1	20	1-410, 1-410, 1-410	RECEPTS 3 COMP SINK DECONTAM	
	RECEPTS 3 COMP SINK DECONTAM	1-410, 1-410, 1-410	20	1	13	0.9	0.2	0.0	14	1	20	1-412, 1-412, 1-412	CENSTRAC DECONTAMINATION	
	CART WASHER	3-48, 1-48, 1-410	35	3	15	3.1	3.1	0.0	16	3	35	3-48, 1-48, 1-410	CART WASHER	
	SONIC IRRIGATOR	3-44, 1-44, 1-48	70	3	21	6.0	6.0	0.0	22	3	70	3-44, 1-44, 1-48	SONIC IRRIGATOR	
	SONIC IRRIGATOR	3-44, 1-44, 1-48	70	3	23	6.0	6.0	0.0	24	3	70	3-44, 1-44, 1-48	AMSCO 7053HP WASHER	
	SONIC IRRIGATOR	3-44, 1-44, 1-48	70	3	25	6.0	6.7	0.0	26	3	70	3-44, 1-44, 1-48	AMSCO 7053HP WASHER	
	CART CHARGING AMSCO 600	1-412, 1-412, 1-412	20	1	33	0.5	0.5	0.0	34	1	20	1-412, 1-412, 1-412	CART CHARGING AMSCO 600	
	CENSTRAC	1-412, 1-412, 1-412	20	1	35	0.4	0.4	0.0	36	1	20	1-412, 1-412, 1-412	RECPT MECH A08A02	
	CENSTRAC	1-412, 1-412, 1-412	20	1	37	0.4	0.2	0.0	38	1	20	1-412, 1-412, 1-412	REC	
	SPARE	--	20	1	39	0.0	0.0	0.0	40	1	20	--	SPARE	
	SPARE	--	20	1	41	0.0	0.0	0.0	42	1	20	--	SPARE	
						33.1 kVA	33.7 kVA	33.8 kVA						
						276 A	281 A	283 A						

LOAD CLASSIFICATION CONNECTED LOAD DEMAND FACTOR ESTIMATED DEMAND PANEL TOTALS

EQUIP 9234 VA 100.00% 9234 VA TOTAL CONNECTED LOAD: 10063 VA

REC 8280 VA 100.00% 8280 VA TOTAL ESTIMATED DEMAND: 10063 VA

TOTAL CONNECTED CURRENT: 279 A
TOTAL ESTIMATED DEMAND CURRENT: 279 A
25 % ADDITIONAL CAPACITY: 70 A
TOTAL PANEL CURRENT: 349 A

NOTES: WHERE NOT LISTED, WIRE AND CONDUIT SHALL BE BE MINIMUM PER SPECIFICATIONS. SPARE BREAKERS TO BE 20A/1P.
1.) BREAKER SHALL BE GFCI PROTECTED.

EXISTING PANEL
PANELBOARD AND WIRING SCHEDULE

PANEL: **BCLDA**
VOLTAGE: 208Y/120V, 3P, 4W
AMPERES: 600 A

MAINS TYPE: MCB
SPD:
MOUNTING: SURFACE

PANEL INTERRUPTING RATING: <ENGINEER TO SPECIFY>
LOCATION: ELEC. A08E011
SUPPLY FROM:

NOTES	CIRCUIT DESCRIPTION	HOT, NEUT, GND	OCB	P	CKT	A	B	C	CKT	P	OCB	HOT, NEUT, GND	CIRCUIT DESCRIPTION	NOTES
	BCLPA6	2 runs of 3-4250, 1-4250, 1-43	400	3	3	33.1	0.0	0.0	4	3	20	--	SPACE	
	SPARE	--	100	3	7	0.0	0.0	0.0	8	3	20	--	SPACE	
	SPARE	--	100	3	11	0.0	0.0	0.0	12	3	100	--	SPACE	
	SPARE	--	225	3	15	0.0	0.0	0.0	16	3	100	--	SPACE	
	BCLPA1	--	225	3	21	0.0	0.0	0.0	22	3	225	--	BCLPA2	
	MAIN	--	600	3	25	0.0	0.0	0.0	26	3	225	--	BCLPA3	
	MAIN	--	600	3	29	0.0	0.0	0.0	30	3	225	--	BCLPA4	
						33.1 kVA	33.7 kVA	33.8 kVA						
						276 A	281 A	283 A						

LOAD CLASSIFICATION CONNECTED LOAD DEMAND FACTOR ESTIMATED DEMAND PANEL TOTALS

EQUIP 9234 VA 100.00% 9234 VA TOTAL CONNECTED LOAD: 10063 VA

REC 8280 VA 100.00% 8280 VA TOTAL ESTIMATED DEMAND: 10063 VA

TOTAL CONNECTED CURRENT: 279 A
TOTAL ESTIMATED DEMAND CURRENT: 279 A
25 % ADDITIONAL CAPACITY: 70 A
TOTAL PANEL CURRENT: 349 A

NOTES: WHERE NOT LISTED, WIRE AND CONDUIT SHALL BE BE MINIMUM PER SPECIFICATIONS. SPARE BREAKERS TO BE 20A/1P.

PANELBOARD AND WIRING SCHEDULE

PANEL: **BCLPA7**
VOLTAGE: 208Y/120V, 3P, 4W
AMPERES: 400 A

MAINS TYPE: MCB
SPD:
MOUNTING: SURFACE

PANEL INTERRUPTING RATING: <ENGINEER TO SPECIFY>
LOCATION: CORRIDOR A08027
SUPPLY FROM: BCLDA2

NOTES	CIRCUIT DESCRIPTION	HOT, NEUT, GND	OCB	P	CKT	A	B	C	CKT	P	OCB	HOT, NEUT, GND	CIRCUIT DESCRIPTION	NOTES
	WORKSTATIONS INSTRUMENT...	1-412, 1-412, 1-412	20	1	1	0.7	0.7	0.0	2	1	20	1-412, 1-412, 1-412	AMSCO WORKSTATION CLEAN...	
	AMSCO WORKSTATION CLEAN...	1-412, 1-412, 1-412	20	1	3	0.7	0.7	0.0	4	1	20	1-412, 1-412, 1-412	AMSCO WORKSTATION CLEAN...	
	AMSCO WORKSTATION CLEAN...	1-412, 1-412, 1-412	20	1	5	0.7	0.7	0.0	6	1	20	1-412, 1-412, 1-412	AMSCO WORKSTATION CLEAN...	
	AMSCO WORKSTATION CLEAN...	1-412, 1-412, 1-412	20	1	7	0.7	0.2	0.0	8	1	20	1-412, 1-412, 1-412	REC	
	AMSCO WORKSTATION CLEAN...	1-412, 1-412, 1-412	20	1	9	0.7	0.2	0.0	10	1	20	1-412, 1-412, 1-412	CENSTRAC	
	AMSCO WORKSTATION CLEAN...	1-412, 1-412, 1-412	20	1	11	0.7	0.2	0.0	12	1	20	1-412, 1-412, 1-412	CENSTRAC	
	AMSCO DRYING CABINET	1-412, 1-412, 1-412	20	1	13	0.2	0.2	0.0	14	1	20	1-412, 1-412, 1-412	REC	
	CENSTRAC DECONTAMINATION	1-412, 1-412, 1-412	20	1	15	0.2	14.3	0.0	16	1	20	1-412, 1-412, 1-412	REC	
	AMSCO 600 ELECTRIC	3-430, 1-430, 1-46	150	3	17	14.3	14.3	0.0	18	3	150	3-430, 1-430, 1-46	AMSCO 600 ELECTRIC	
	AMSCO 600	3-412, 1-412, 1-412	20	3	23	1.2	1.2	0.0	24	3	20	3-412, 1-412, 1-412	AMSCO 600	
	RECEPTS 3 COMP SINK DECONTAM	1-412, 1-412, 1-412	20	1	29	1.2	0.9	0.0	30	1	20	1-412, 1-412, 1-412	RECEPTS 3 COMP SINK DECONTAM	
	RECEPTS 3 COMP SINK DECONTAM	1-412, 1-412, 1-412	20	1	31	0.2	0.2	0.0	32	1	20	1-412, 1-412, 1-412	AMSCO WORKSTATIONS EMI...	
	CENSTRAC CLEAN WORK	1-412, 1-412, 1-412	20	1	33	0.2	0.2	0.0	34	1	20	1-412, 1-412, 1-412	CENSTRAC DECONTAMINATION	
	CART CHARGING AMSCO 600	1-412, 1-412, 1-412	20	1	35	0.5	0.5	0.0	36	1	20	1-412, 1-412, 1-412	MONITOR CLEAN WORK	
	CENSTRAC CART HOLD	1-412, 1-412, 1-412	20	1	37	0.4	0.2	0.0	38	1	20	1-412, 1-412, 1-412	CART CHARGING AMSCO 600	
	SPARE	--	20	1	39	0.0	0.0	0.0	40	1	20	--	SPARE	
	SPARE	--	20	1	41	0.0	0.0	0.0	42	1	20	--	SPARE	
						34.6 kVA	34.8 kVA	35.0 kVA						
						288 A	290 A	300 A						

LOAD CLASSIFICATION CONNECTED LOAD DEMAND FACTOR ESTIMATED DEMAND PANEL TOTALS

EQUIP 9436 VA 100.00% 9436 VA TOTAL CONNECTED LOAD: 105376 VA

REC 10880 VA 95.54% 10490 VA TOTAL ESTIMATED DEMAND: 106895 VA

TOTAL CONNECTED CURRENT: 291 A
TOTAL ESTIMATED DEMAND CURRENT: 291 A
25 % ADDITIONAL CAPACITY: 73 A
TOTAL PANEL CURRENT: 364 A

NOTES: WHERE NOT LISTED, WIRE AND CONDUIT SHALL BE BE MINIMUM PER SPECIFICATIONS. SPARE BREAKERS TO BE 20A/1P.

PANELBOARD AND WIRING SCHEDULE

PANEL: **BCLPA8**
VOLTAGE: 208Y/120V, 3P, 4W
AMPERES: 400 A

MAINS TYPE: MCB
SPD:
MOUNTING: SURFACE

PANEL INTERRUPTING RATING: <ENGINEER TO SPECIFY>
LOCATION: CORRIDOR A08027
SUPPLY FROM: BCLDA2

NOTES	CIRCUIT DESCRIPTION	HOT, NEUT, GND	OCB	P	CKT	A	B	C	CKT	P	OCB	HOT, NEUT, GND	CIRCUIT DESCRIPTION	NOTES
	AMSCO 600	3-412, 1-412, 1-412	20	3	3	1.2	1.2	0.0	4	3	20	3-412, 1-412, 1-412	AMSCO 600	
	AMSCO 600	3-412, 1-412, 1-412	20	3	9	1.2	1.2	0.0	10	3	20	3-412, 1-412, 1-412	AMSCO 600	
	LOW TEMP STERILIZER	3-412, 1-412, 1-412	20	3	13	1.9	1.9	0.0	14	3	20	3-412, 1-412, 1-412	LOW TEMP STERILIZER	
	LOW TEMP STERILIZER	3-412, 1-412, 1-412	20	3	15	1.9	1.9	0.0	16	3	20	3-412, 1-412, 1-412	LOW TEMP STERILIZER	
	LOW TEMP STERILIZER	3-412, 1-412, 1-412	20	3	17	1.9	1.9	0.0	18	3	20	3-412, 1-412, 1-412		



PROJECT ARCHITECT
 332 E. 8th ST.
 Cincinnati, OH 45202-2217
 v 513.241.8700
 GBBN.COM



Renovate / Upgrade
 UK Healthcare
 Facilities
 Pavilion A Level B
 Project Number:
 2239.77

OWNER

University of Kentucky
 222 Peterson Service Building
 Lexington, KY 40506

CONSULTANTS

MEP ENGINEERS
 CMTA Engineers
 2429 Members Way
 Lexington, KY 40504
 859.253.0892

SUPPLY CHAIN ENGINEER

St. Onge Company
 1400 Williams Road
 York, PA 17402
 717.840.8181

FOOD SERVICE

Rippe Associates
 10400 Yellow Cir Dr #100
 Minnetonka, MN 55343
 952.933.0313

STRUCTURAL ENGINEER

Brown + Kubican
 2224 Young Drive
 Lexington, KY 40505
 859.543.0933

DRAWING ISSUE


CONTRACT DOCUMENTS

NO	DATE	DESCRIPTION
1	05.20.22	CD/BID DOCUMENTS BP#2
2	9.20.22	BP2 - ADD#6

DRAWING TITLE

**LEVEL 0B - PLUMBING
 NEW WORK PLAN -
 AREA A - PHASE 1**

SEAL

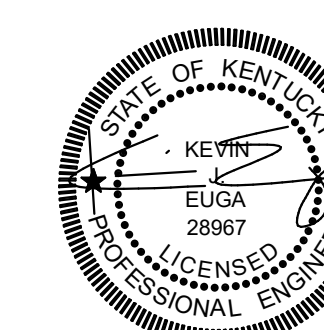


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14590.01

P31B-A


02/04/2022

TAGGED NOTES
 P107 VALVES PROVIDED BY OWNER, INSTALLED BY PLUMBING CONTRACTOR.

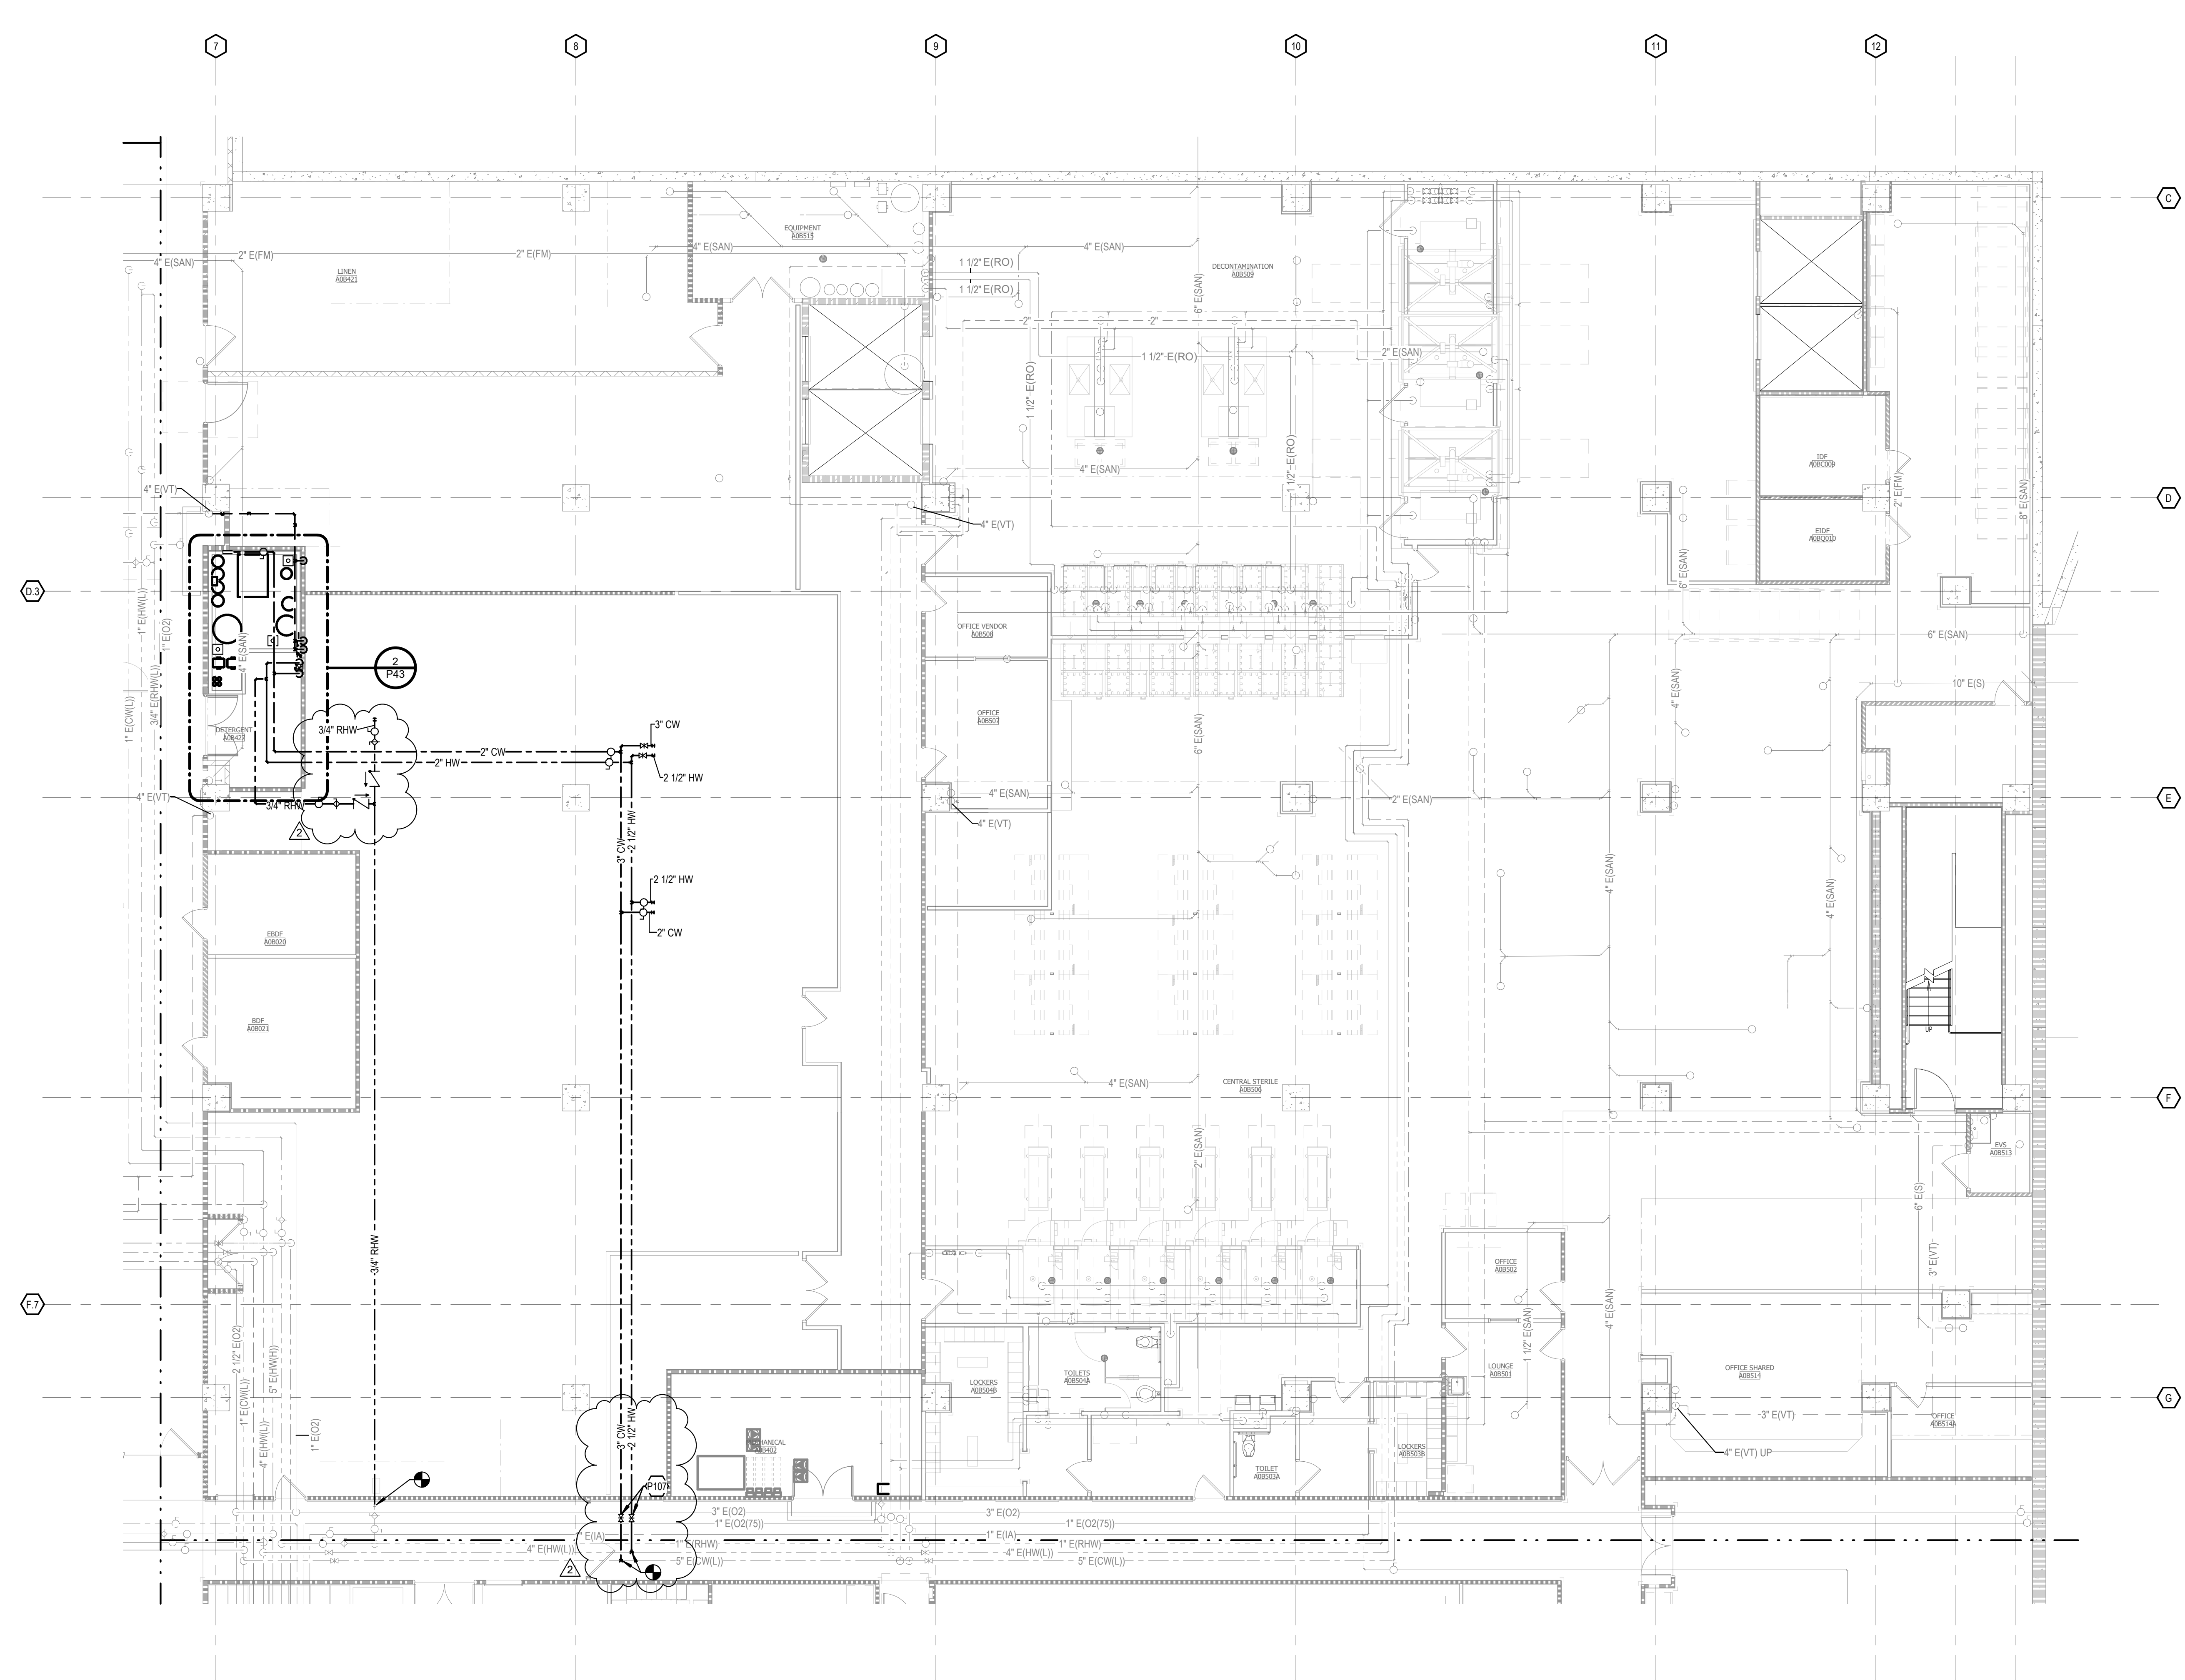


**LEVEL 0B - PLUMBING NEW WORK PLAN -
 AREA A - PHASE 2.1**

SCALE: 1/8" = 1'-0"
 0 2' 4' 8' 16' 24' 32'

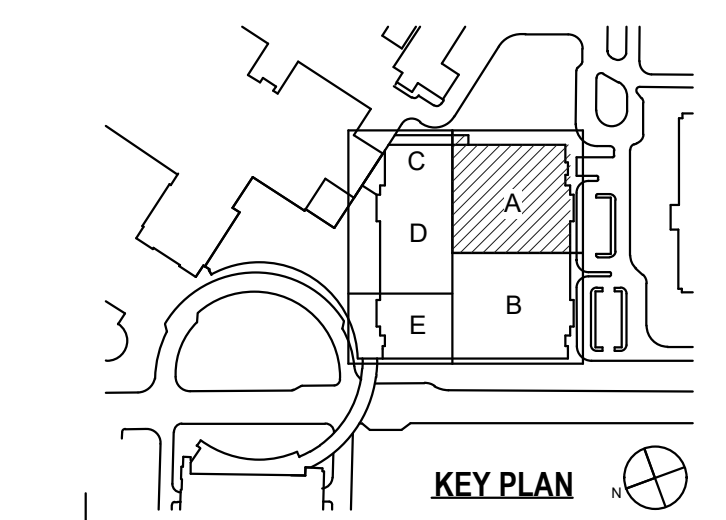

02/04/2022 11:08:35 AM BIM 360://UK - Pavilion A - Level B Support Services/Revolution/2022/02/04/2022/Center File.rvt

KITCHEN - ADDITIONAL TRENCH DRAIN | PAVILION A, 1000 S. LIMESTONE, LEXINGTON, KY 40536

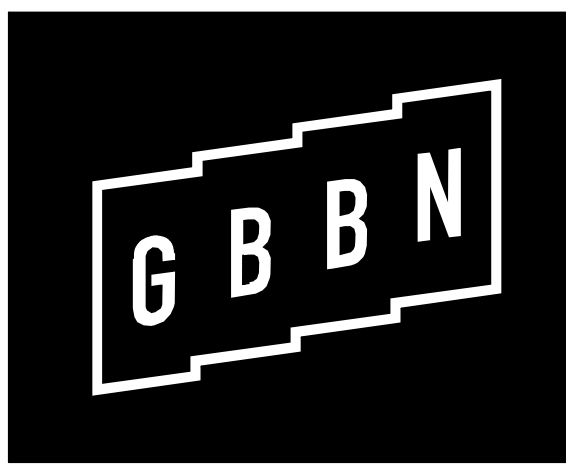

PROJECT ARCHITECT
332 E. 8th St.
Cincinnati, OH 45202-2217
v 513.241.8700
GBBN.COM



Renovate / Upgrade
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Project Number:
2239.77

OWNER

University of Kentucky

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Lexington, KY 40506

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DRAWING ISSUE


CONTRACT DOCUMENTS

NO	DATE	DESCRIPTION
1	05.20.22	CDB/D DOCUMENTS BP#2
2	9.20.22	BP2 - ADD#6

DRAWING TITLE

**ENLARGED PLUMBING
PLAN - AREA A**

SEAL

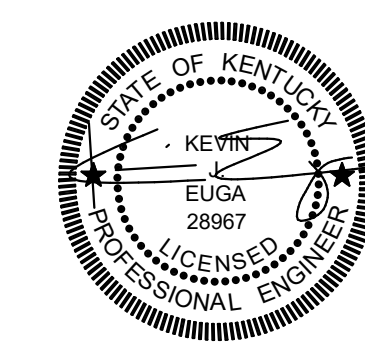

JOB NUMBER


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P43


02/04/2022

TAGGED NOTES

- # P23 3 BAY SINK SUPPLIED BY EQUIPMENT SERVICE EQUIPMENT CONTRACTOR, INSTALLED BY PLUMBING CONTRACTOR. PROVIDE WASTE AND WATER CONNECTIONS INCLUDING DRAIN PIPES, P-TRAP, CONTINUOUS DRAINS, WATER SUPPLIES AND ANGLE STOPS AND ESCUTCHEONS. PROVIDING FINAL CONNECTIONS TO BOTH FAUCETS, AIR GUN, WATER GUN AND PURE WATER SPOUT. COORDINATE EXACT CONNECT POINTS WITH EACH SINK SHOP DRAWING AND CONNECTION CONFIGURATION.
- # P24 SONIC IRRIGATOR SUPPLIED BY EQUIPMENT SUPPLIER. PROVIDE 3/4" COLD WATER, 3/4" HOT WATER AND 3/4" RO WATER CONNECTIONS. PROVIDE SHUT-VALVES AND MAKE FINAL CONNECTIONS TO EQUIPMENT. PROVIDE 3/4" DRAIN PIPE AND INSTALL DRAIN PIPE AND OVERFLOW HOSE INDIRECTLY TO FLOOR SINK. REFER THE SONIC IRRIGATOR UTILITY DETAIL SHEET.
- # P25 CART WASHER BY EQUIPMENT SUPPLIER. PROVIDE 1" COLD WATER, 1" HOT WATER, 1/2" RO WATER AND 1/2" AIR CONNECTIONS. PROVIDE SHUT-VALVES, FRY, BACKFLOW PREVENTER, WATER HAMMER ARRESTOR AND MAKE FINAL CONNECTIONS TO EQUIPMENT. PROVIDE 4" DRAIN PIPE AND INSTALL INDIRECTLY TO FLOOR DRAIN. REFER TO CART WASHER UTILITY.
- # P29 PROVIDE PVC CONDUIT ABOVE CEILING FROM DETERGENT PUMP ROOM TO WASHER LOCATIONS FOR DETERGENT SUPPLIES.
- # P30 PROVIDE NEW COMPLETE RO WATER TREATMENT SYSTEM INCLUDING RO SYSTEM, CARBON FILTER, SOFTENERS, DISTRIBUTION PUMP, STORAGE TANK, DI TANKS, BYPASS HEADER, ALL INTERCONNECTION PIPES, FITTING AND VALVES. SYSTEM SHALL BE PROVIDED BY ULTRA PURE WATER TECHNOLOGIES. PLUMBING CONTRACTOR SHALL BE RESPONSIBLE FOR ALL MATERIAL AND INSTALLATION COST.
- # P31 SINGLE CHAMBER WASHER/DISINFECTOR SUPPLIED BY EQUIPMENT SUPPLIER. PROVIDE 1/2" COLD WATER, 1/2" HOT WATER, 1/2" RO WATER AND 1/2" AIR CONNECTIONS. PROVIDE SHUT-VALVES AND MAKE FINAL CONNECTIONS TO EQUIPMENT. PROVIDE 1-1/2" DRAIN PIPE AND INSTALL INDIRECTLY TO FLOOR SINK. REFER TO UTILITY DETAIL SHEET.
- # P71 REFER TO THE MOP BASIN DETAIL, SHEET P51-A
- # P72 INSTALL PLUMBING PIPES DOWN IN UTILITY CHASE AND THEN HORIZONTALLY IN HALF WALL TO SINKS.
- # P74 ALL "FD-3" FLOOR SINKS SHALL BE INSTALLED WITH 3/4" GRATE FLUSH WITH FINISHED FLOOR.
- # P77 PROVIDE CARBON FILTER
- # P78 PROVIDE RO SYSTEM UNIT.
- # P79 PROVIDE RO DISTRIBUTION PUMP WITH NEMA 4X CONTROL PANEL WITH SINGLE POWER SOURCE DISCONNECT SWITCH.
- # P80 PROVIDE RO WATER STORAGE TANK WITH FLOAT SWITCHES TO RO WATER SYSTEM ON/OFF. SPRAY NOZZLE ON THE RETURN LOOP SIDE OF TANK AND VENT FILTER.
- # P81 PROVIDE DI TANKS AND DI BY-PASS HEADER.
- # P82 PROVIDE LINE SIZE WATTS LF909 BACKFLOW PREVENTERS IN WATER SUPPLIES TO SPD EQUIPMENT. ASSEMBLY SHALL BE PROVIDED WITH BALL VALVES AND STRAINER AND AIR GAP FITTING. PROVIDE DRAIN PIPE FROM AIR GAP FITTING DOWN TO FLOOR DRAIN.
- # P83 PROVIDE THERMOSTATIC MIXING VALVE TO PROVIDE TEPID WATER SUPPLY TO RO WATER SYSTEM.
- # P84 PROVIDE 24"X50" BRINE TANK.
- # P86 SPACE RESERVED FOR DETERGENT EQUIPMENT.
- # P87 SPACE RESERVED FOR SALT PALET.
- # P89 PROVIDE LINE SIZE WATTS LF909 BACKFLOW PREVENTERS IN WATER SUPPLIES TO RO WATER SYSTEM. ASSEMBLY SHALL BE PROVIDED WITH BALL VALVES AND STRAINER AND AIR GAP FITTING. PROVIDE DRAIN PIPE FROM AIR GAP FITTING DOWN TO FLOOR DRAIN.
- # P90 PROVIDE WATER SOFTENER.
- # P93 PROVIDE PRESSURE REGULATOR VALVE TO REDUCE COMPRESSED AIR SUPPLY TO 30 PSI.
- # P94 PROVIDE MULTI-CARTRIDGE DISTRIBUTION LOOP HOUSING ASSEMBLY WITH PALL ENDOTOXIN FILTERS.
- # P95 PROVIDE ALARM PANEL.
- # P96 PROVIDE TEMPORARY RO WATER LOOP TO SUPPLY EXISTING EQUIPMENT.

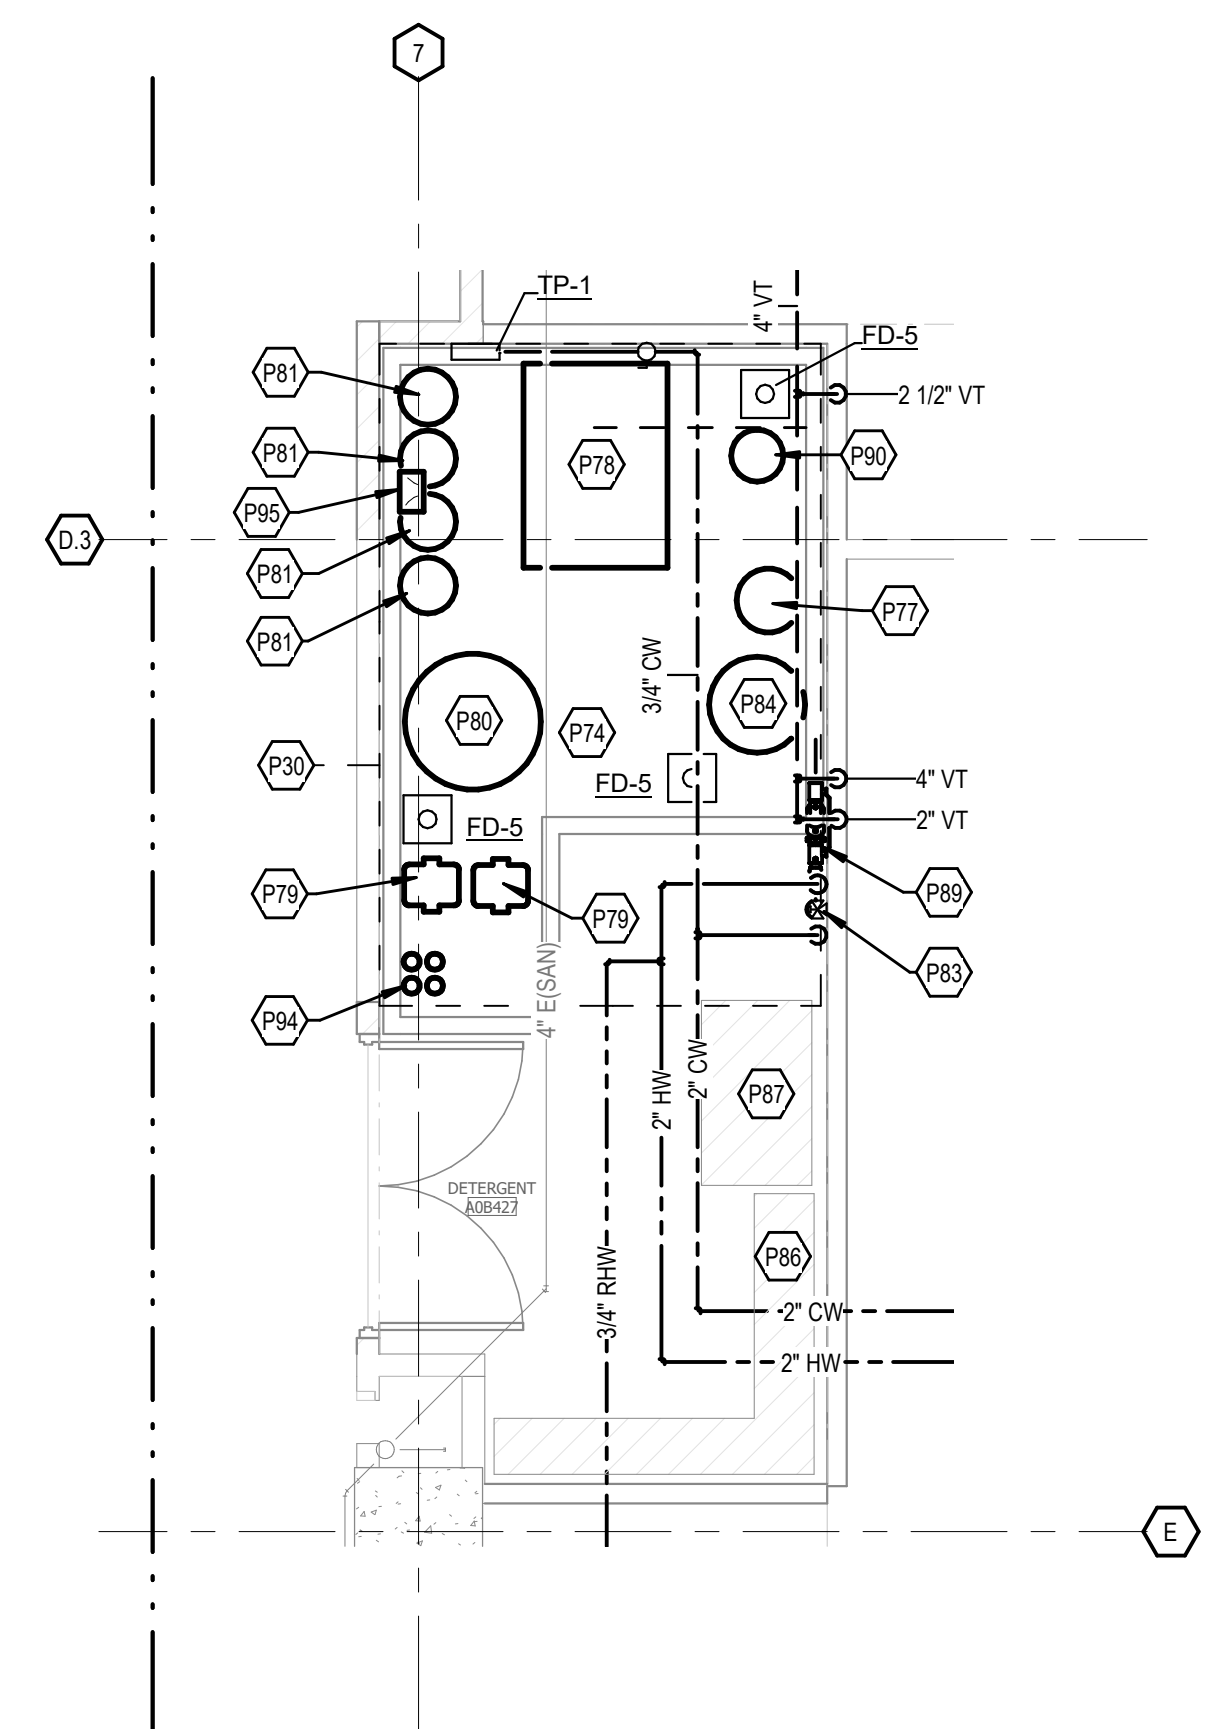

ENLARGED DETERGENT/RO WATER SYSTEM ROOM PLUMBING PLAN - PHASE 2.1
SCALE: 1/4" = 1'-0"

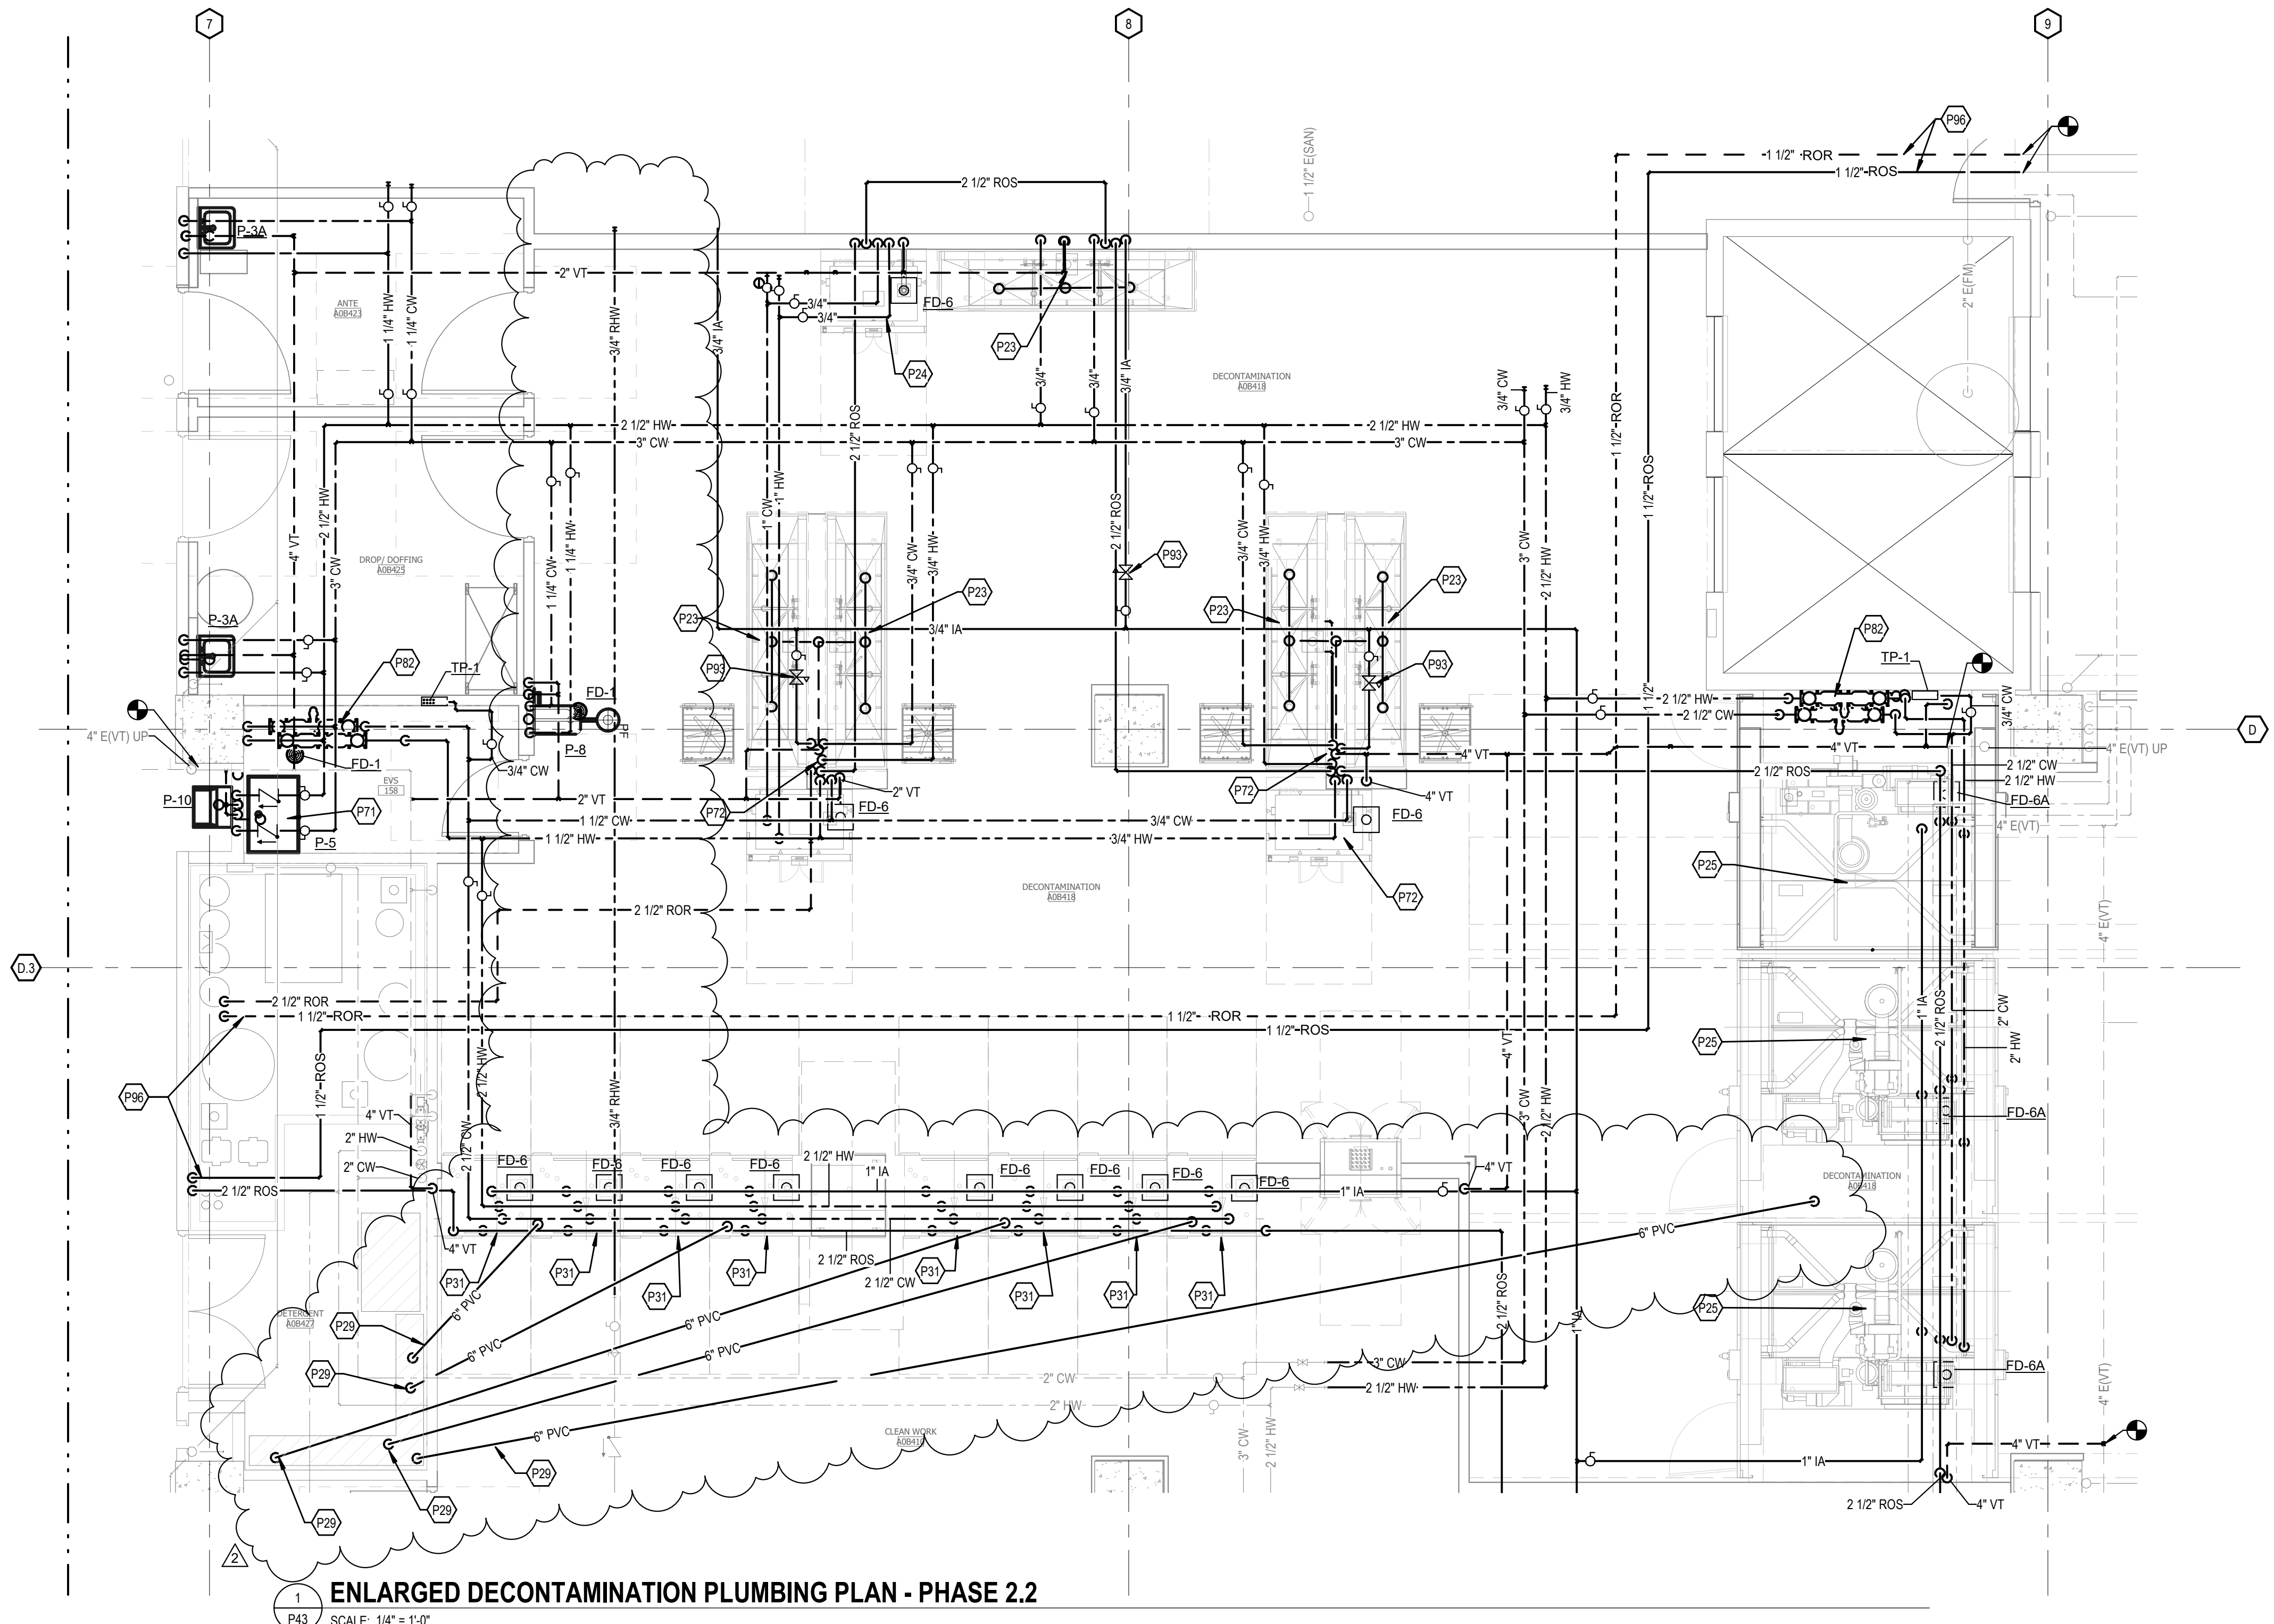

ENLARGED DECONTAMINATION PLUMBING PLAN - PHASE 2.2
SCALE: 1/4" = 1'-0"

